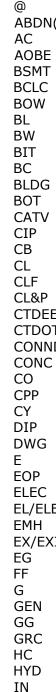
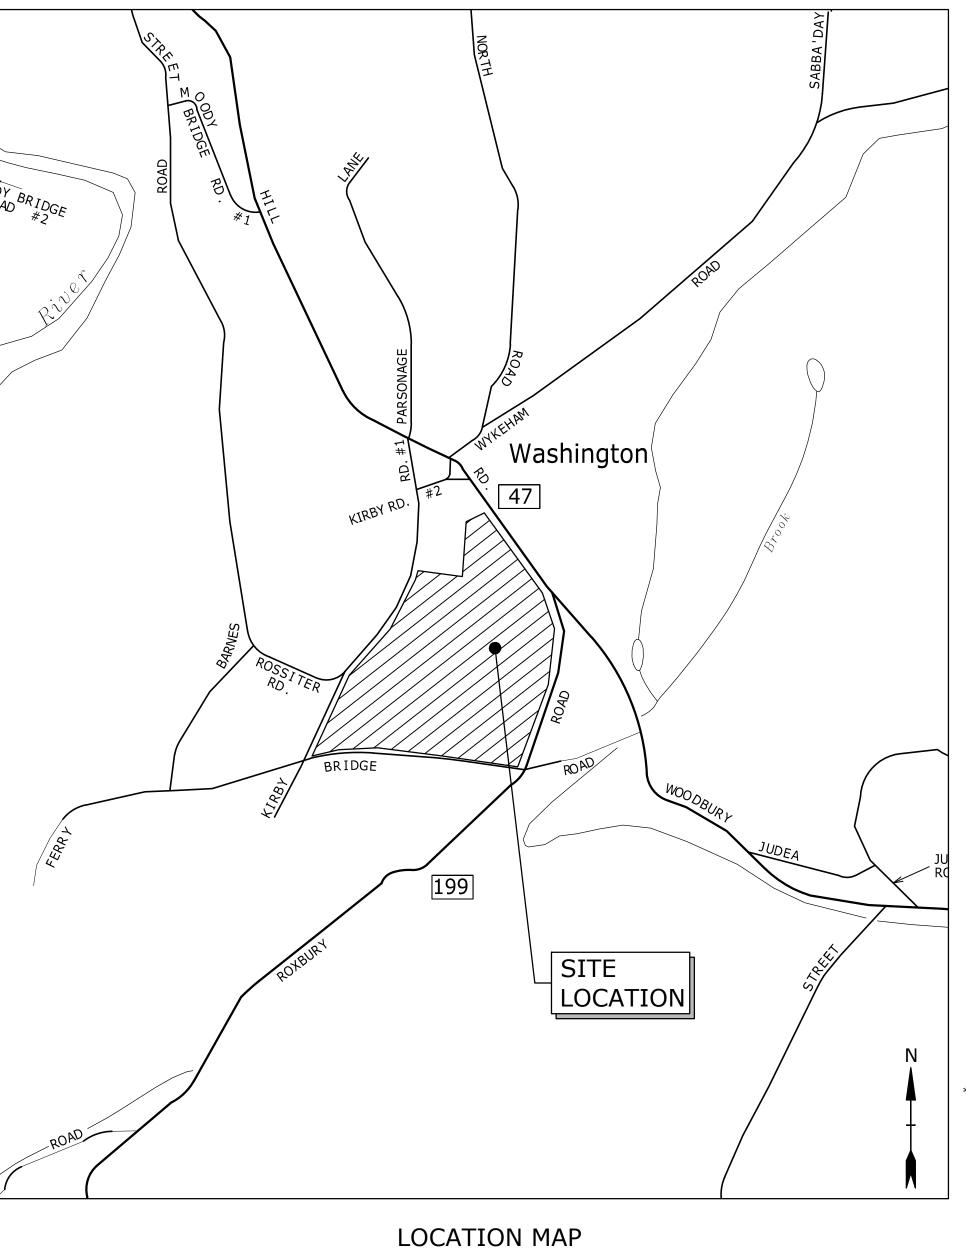
GENERAL NOTES

- 1. UTILITY, STRUCTURE AND FACILITY LOCATIONS SHOWN HEREON WERE PLOTTED FROM INFORMATION SUPPLIED BY RESPECTIVE UTILITY COMPANIES AND DATA OBTAINED FROM FIELD SURVEYS AND AS-BUILT DRAWINGS. THE ACCURACY AND COMPLETENESS OF SUBSURFACE INFORMATION SHOWN ON THESE DRAWINGS IS NOT GUARANTEED. THE CONTRACTOR SHALL DETERMINE FOR HIMSELF, THE LOCATIONS AND ELEVATIONS OF ALL UTILITIES WHICH MAY AFFECT HIS CONSTRUCTION OPERATIONS. THE CONTRACTOR MUST ADEQUATELY PROTECT AND SUPPORT UTILITIES AND HE SHALL BE RESPONSIBLE FOR ALL DAMAGE INCURRED AT NO EXPENSE TO THE OWNER. ANYONE USING UTILITY INFORMATION AND DATA PROVIDED HEREIN SHALL CONTACT "CALL BEFORE YOU DIG", 1-800-922-4455 OR WWW.CBYD.COM, 72 HOURS IN ADVANCE TO VERIFY THE LOCATION OF UTILITIES PRIOR TO STARTING CONSTRUCTION.
- 2. REFERENCE IS MADE TO PLAN ENTITLED TOPOGRAPHIC SURVEY SCIENCE BUILDING PROJECT THE FREDERICK GUNN SCHOOL, 22 KIRBY ROAD, WASHINGTON, CT" DATED MAY 18, 2021, LATEST REVISION DECEMBER 14, 2021. PREPARED BY SMITH & COMPANY SURVEYORS & ENGINEERS, INC. 247 MAIN STREET SOUTH, WOODBURY, CT.
- 3. IT IS THE RESPONSIBILITY OF EACH BIDDER IN EVALUATING THESE PLANS TO MAKE EXAMINATIONS IN THE FIELD BY VARIOUS METHODS AND OBTAIN NECESSARY INFORMATION FROM AVAILABLE RECORDS, UTILITY COMPANIES, AND INDIVIDUALS AS TO THE LOCATION OF SUBSURFACE STRUCTURES.
- 4. IT IS THE RESPONSIBILITY OF THE CONTRACTOR TO REVIEW ALL OF THE DRAWINGS AND SPECIFICATIONS ASSOCIATED WITH THIS PROJECT WORK SCOPE PRIOR TO THE INITIATION OF CONSTRUCTION. SHOULD THE CONTRACTOR FIND A CONFLICT WITH THE DOCUMENTS RELATIVE TO THE DRAWINGS, SPECIFICATIONS OR APPLICABLE CODES, IT IS THE CONTRACTOR'S RESPONSIBILITY TO NOTIFY THE OWNER'S REPRESENTATIVE IN WRITING PRIOR TO THE START OF CONSTRUCTION. FAILURE BY THE CONTRACTOR TO NOTIFY THE OWNER'S REPRESENTATIVE SHALL CONSTITUTE ACCEPTANCE OF FULL RESPONSIBILITY BY THE CONTRACTOR TO COMPLETE THE SCOPE OF WORK AS DEFINED BY THE DRAWINGS AND IN FULL CONFORMANCE WITH LOCAL REGULATIONS AND CODES.
- 5. AT ALL LOCATIONS WHERE THE CONTRACTOR IS REQUIRED TO REMOVE EXISTING PAVEMENT AREAS (WHICH ARE NOT TO BE RECONSTRUCTED) FOR THE INSTALLATION OF THE PROPOSED UTILITIES, THE PAVEMENT SHALL BE REPAIRED AS SHOWN ON THE CONTRACT DRAWINGS OR IN ACCORDANCE WITH CITY OR STATE REQUIREMENTS AS APPLICABLE.
- 6. AS CONSTRUCTION IS COMPLETED, THE CONTRACTOR SHALL REMOVE ALL EXCESS MATERIAL, DEBRIS, ETC. AND RESTORE OR REPLACE ANY DAMAGE TO LANDSCAPING.
- 7. AREAS OUTSIDE THE PROJECT LIMIT LINE DISTURBED BY CONSTRUCTION SHALL BE RETURNED TO THEIR ORIGINAL CONDITION OR BETTER AND SHALL BE GRADED TO MEET PROPOSED CONSTRUCTION AS DIRECTED BY THE OWNER'S REPRESENTATIVE. COST FOR THIS WORK SHALL BE BORNE BY THE CONTRACTOR AT NO ADDITIONAL COST TO THE OWNER.
- 8. THE CONTRACTOR SHALL PROCURE ALL THE NECESSARY PERMITS AND LICENSES, AT THE TIME REQUIRED, PAY ALL THE CHARGES AND FEES, AND GIVE NOTICES AS NECESSARY AND DUE IN CONNECTION WITH THE LAWFUL EXECUTION OF THE WORK AT NO ADDITIONAL COST TO THE OWNER.
- 9. ALL UTILITY BOXES, FRAMES, AND GRATES, ETC. AFFECTED BY THE CONSTRUCTION ACTIVITIES SHALL BE RESET/RECONSTRUCTED TO THE PROPER GRADE. ALL COST RELATED TO SUCH WORK SHALL BE CONSIDERED INCLUDED IN THE BID PRICE.
- 10. EXCAVATION OF ANY TYPE SHALL BE ACCOMPLISHED IN SUCH A MANNER THAT UNDERGROUND UTILITIES OR STRUCTURES ARE NOT DAMAGED. IT SHALL BE THE CONTRACTOR'S SOLE RESPONSIBILITY FOR ANY DAMAGES INCURRED DURING EXCAVATION OPERATIONS. ALL EXCAVATION SHALL BE IN CONFORMANCE WITH THE LATEST OSHA REQUIREMENTS.
- 11. ALL DRIVEWAYS, ROADS, STAIRS, AND SIDEWALKS DISTURBED BY THE CONSTRUCTION IN OR OUTSIDE THE PROJECT LIMIT LINE SHALL BE RETURNED TO THEIR ORIGINAL CONDITION OR BETTER AND SHALL BE GRADED TO MEET THE PROPOSED CONSTRUCTION AS DIRECTED BY THE OWNER'S REPRESENTATIVE AT NO ADDITIONAL COST TO THE OWNER.
- 12. THE CONTRACTOR SHALL SUFFICIENTLY COVER ALL DISTURBED AREAS AT THE END OF EACH WORK DAY TO AVOID ANY RISK OF INJURY TO PEDESTRIAN OR VEHICULAR TRAFFIC. THE CONTRACTOR SHALL INSTALL TEMPORARY SUPPORT SYSTEMS OVER TRENCH EXCAVATIONS THAT ARE TAMPER RESISTANT AND SAFE FOR VEHICULAR AND PEDESTRIAN TRAFFIC. THE CONTRACTOR SHALL INSTALL BARRICADES TO PROTECT AGAINST PEDESTRIAN ACCESS. THE CONTRACTOR SHALL OBTAIN APPROVAL OF THE TEMPORARY SAFETY MEASURES BY THE OWNER'S REPRESENTATIVE. ALL MAINTENANCE AND PROTECTION OF BOTH PEDESTRIAN AND VEHICULAR TRAFFIC ARE INCLUDED IN THE LUMP SUM BID PRICE FOR THIS PROJECT.
- 13. THE STANDARD SPECIFICATIONS (FOR SITE /CIVIL WORK) SHALL BE THE STATE OF CONNECTICUT, DEPARTMENT OF TRANSPORTATION, STANDARD SPECIFICATIONS FOR ROADS, BRIDGES, AND INCIDENTAL CONSTRUCTION, FORM 818, 2020, INCLUDING ALL SUPPLEMENTS THERETO.
- 14. ALL DISTURBED AREAS NOT PROVIDED WITH SPECIFIC SITE IMPROVEMENTS (PAVING, CONCRETE SIDEWALK, LANDSCAPING, ETC.) SHALL HAVE TOPSOIL INSTALLED AND TURF ESTABLISHED IN ACCORDANCE WITH THE PROJECT LANDSCAPE SPECIFICATIONS.
- 15. THE CONTRACTOR SHALL RECORD THE LOCATIONS OF ALL UNDERGROUND UTILITIES INSTALLED OR FOUND DURING CONSTRUCTION. THE UTILITIES SHALL BE MEASURED FROM PERMANENT SURFACE FEATURES AND COMPILED BY THE CONTRACTOR ON RECORD DRAWINGS. AN AS-BUILT SURVEY, SHALL BE PREPARED BY A SURVEYOR LICENSED IN THE STATE OF CONNECTICUT SUBMITTED TO THE OWNER AND ENGINEER FOR REVIEW AND APPROVAL 2 WEEKS PRIOR TO APPLYING FOR CERTIFICATE OF OCCUPANCY.
- 16. THE CONTRACTOR SHALL COMPLETE ALL WORK SO THAT ANY MATERIALS WHICH ARE TO REMAIN IN PLACE OR WHICH ARE TO REMAIN THE PROPERTY OF THE OWNER, WILL NOT BE DAMAGED. IF THE CONTRACTOR DAMAGES ANY MATERIALS WHICH ARE TO REMAIN, OR WHICH ARE TO REMAIN THE PROPERTY OF THE OWNER, THE DAMAGED MATERIALS SHALL BE REPLACED TO THE SATISFACTION OF THE OWNER'S REPRESENTATIVE AT THE EXPENSE OF THE CONTRACTOR.
- 17. AFTER CONSTRUCTION IS COMPLETED, THE CONTRACTOR SHALL REMOVE ALL EXCESS MATERIAL, DEBRIS, EQUIPMENT, ETC. AND RESTORE OR REPAIR ANY DAMAGE TO LANDSCAPING AS DIRECTED BY THE OWNER'S REPRESENTATIVE.
- 18. THE CONTRACTOR SHALL ANTICIPATE IN HIS BID THAT THE AREA OF HIS PROPOSED WORK MAY BE ENCUMBERED BY UTILITY COMPANIES FOR THE REMOVAL/RELOCATION/ADJUSTMENT/CONSTRUCTION OF UTILITIES. THE CONTRACTOR'S ATTENTION IS DIRECTED TO THE REQUIRED NOTIFICATIONS. THE CONTRACTOR SHALL COORDINATE ALL ASPECTS OF HIS WORK WITH SAID UTILITY COMPANIES.
- 19. THE CONTRACTOR SHALL EXCAVATE AND LEGALLY DISPOSE OF OFF-SITE ANY EXCESS PAVEMENT AND/OR BASE. THE COST FOR THIS WORK SHALL BE INCLUDED IN THE LUMP SUM BID FOR THE PROJECT AND AT NO ADDITIONAL COST TO THE OWNER.
- 20. ALL PROPOSED WORK MAY BE VARIED IN THE FIELD BY THE OWNER'S REPRESENTATIVE TO MEET EXISTING CONDITIONS.

PARKING COUNT		
PARKING TYPE	QUANTITY (EXISTING)	
*MAIN CAMPUS EXISTING PARKING	146	
PARKING LOST	0	
PROPOSED PARKING ADDED	0	
NET GAIN	0	
*TOTAL PROPOSED MAIN CAMPUS PARKING	146	
*TOTAL PROPOSED MAIN CAMPUS ADA PARKING	5	

(APPROXIMATE BASED ON THE 2017 ZBA APPLICATION FOR THE THOMAS S. PERAKOS ARTS AND COMMUNITY CENTER)





SCALE: 1" = 600'

STANDARD ABBREVIATIONS

I('D)	AT ABANDON(ED) ACRE/AIR CONDITIONING AS ORDERED BY THE ENGINEER BASEMENT BITUMINOUS CONCRETE LIP CURBING	INC INV L LT LOC LP
i	BACK OF WALK BASELINE BOTTOM OF WALL BITUMINOUS BOTTOM OF CURB BUILDING	MAX MIN MH MISC MON NIC
	BOTTOM CABLE TELEVISION CAST IRON PIPE CATCH BASIN CENTERLINE CHAIN LINK FENCE	N CATV NTS N/A N/F OH
EP)T NDOT	CONNECTICUT LIGHT & POWER CONNECTICUT DEPT. OF ENERGY & ENV. PROTECTION CONNECTICUT DEPT. OF TRANSPORTATION CONNECTICUT DEPT. OF TRANSPORTATION CONCRETE CLEAN-OUT	PC PCC PCPP PED PI PT
	CORRUGATED POLYETHYLENE PIPE CUBIC YARDS DUCTILE IRON PIPE DRAWING EAST/ELECTRIC EDGE OF PAVEMENT	PRC PS PVC R REV ROW
.EV	ELECTRIC ELEVATION ELECTRIC MANHOLE	RT SAN SCH
KIST	ELECTRIC MANHOLE EXISTING EXISTING GRADE FIRST FLOOR GAS GENERATOR GAS GATE GALVANIZED RIGID CONDUIT HANDICAP HYDRANT INCHES	SCH SF STA STD STRM T TEL TF TC TW W WG/W
		WG/W

INC	INCORPORATED
INV	INVERT
L	LENGTH OF CURVE
LT	LEFT
LOC	LOCATION
LP	LIGHT POLE
MAX	MAXIMUM
MIN MH	MINIMUM MANHOLE
MISC	MISCELLANEOUS
MON	MONUMENT
NIC	NOT IN CONTRACT
N	NORTH
CATV	CABLE TELEVISION
NTS	NOT TO SCALE
N/A	NOT APPLICABLE
N/F	NOW OR FORMERLY
ОН	OVERHEAD
PC	POINT OF CURVATURE
PCC	POINT OF COMPOUND CURVATURE
PCPP	PERFORATED CORRUGATED POLYETHYLENE
PED PI	PEDESTRIAN POINT OF INTERSECTION
PT	POINT OF TANGENCY
PRC	POINT OF REVERSE CURVATURE
PS	PARKING SPACES
PVC	POLYVINYL CHLORIDE
R	RADIUS
REV	REVISION
ROW	RIGHT OF WAY
RT	RIGHT
SAN	SANITARY
SCH	SCHEDULE
SF	SQUARE FEET
S STA	SOUTH STATION
STA	STANDARD
STRM	STORM
T	TANGENT LENGTH/TEL-DATA
TEL	TEL-DATA
TF	TOP OF FRAME
ТҮР	TYPICAL
TC	TOP OF CURB
TW	TOP OF WALL
W	WATER
WG/WV	WATER GATE/VALVE
XFMR	TRANSFORMER
&	AND

LEGEND
DESCRIPTION
PROPERTY LINE
PROJECT LIMIT LINE
MINOR CONTOUR
MAJOR CONTOUR
SPOT ELEVATION
TREES
TREE LINE
EDGE OF PAVEMENT
CURB LINE
RETAINING WALL
CONCRETE WALK
EXTERIOR STAIRS
BUILDING
FENCE
SIGN & SIGN POST
BOLLARD
PARKING PAINT LINE
STORM SEWER
STORM MANHOLE
CATCH BASIN
AREA DRAIN
SANITARY SEWER
SANITARY MANHOLE
SANITARY FORCE MAIN
WATER MAIN
WATER VALVE
WATER SERVICE
FIRE PROTECTION SERVICE
HYDRANT
GAS MAIN/SERVICE
GAS GATE
GAS METER
PRIMARY ELECTRIC SERVICE
TRANSFORMER
TEL-DATA - BURIED
OVERHEAD WIRES
CABLE TV
UTILITY POLE
LIGHT POLE
TEST PIT

ZONING DA

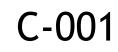
ZONE R1 - FARMING AND RESIDENTIAL DISTRICT WITH APPROX TOTAL PARCEL ACREAGE: 21.7 ACRES ±

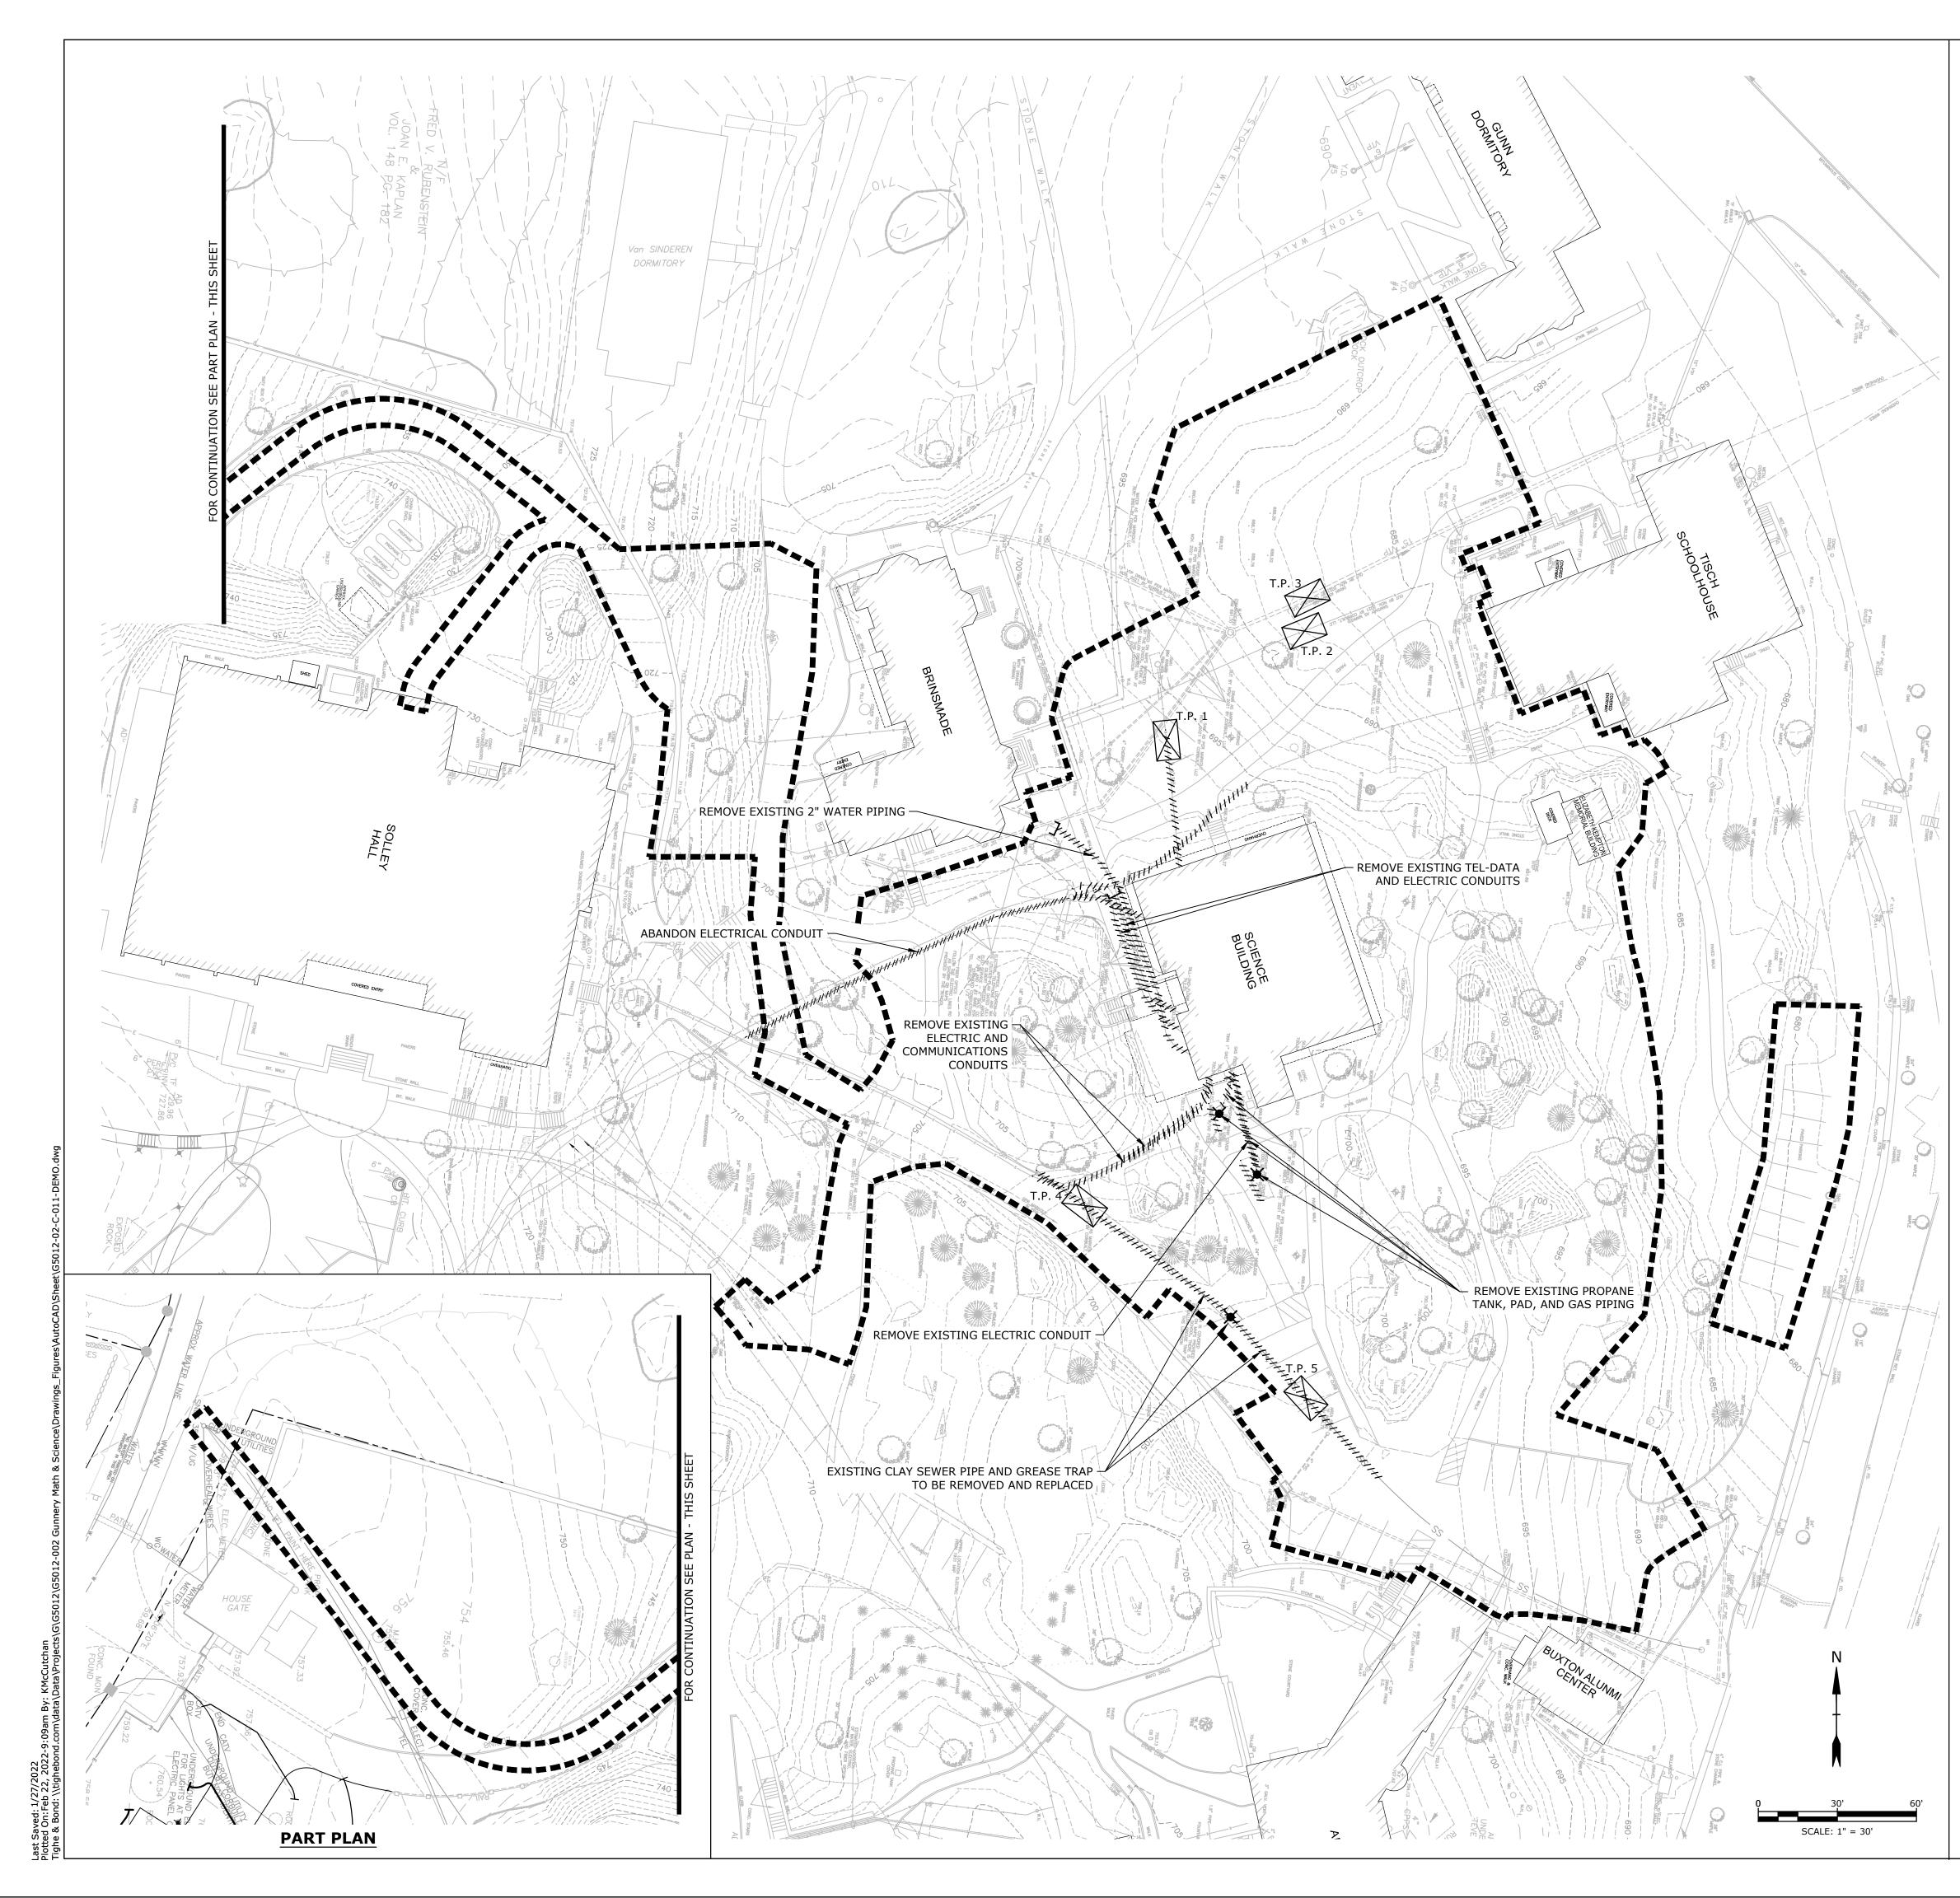
CHARACTERISTICS	REQUIREM
ZONING SETBACKS:	
FRONT YARD	50'-0"
SIDE YARD	25'-0"
REAR YARD	25'-0"
MAXIMUM LOT COVERAGE:	10%
MINIMUM GROUND FLOOR AREA:	600 SQUARE
MINIMUM LOT WIDTH:	200'-0"
MAXIMUM BUILDING HEIGHT:	MAX. MEAN HEIGH MAX. TOTAL VERTICAL (MEASURED FROM PRE-EXISTING (
PARKING REQUIREMENTS:	MIN: 1 SPACE PER 5 SEAT MAX: 1 SPACE PER 3 SEAT REQUIRED: 83-13
HANDICAP SPACES:	5 SPACES (INC. 1 V
MAXIMUM DRIVEWAY WIDTH:	30'-0"
(APPROXIMATE BASED ON THE 2	017 ZBA APPLICATION FOR

THE THOMAS S. PERAKOS ARTS AND COMMUNITY CENTER)

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-			Tighe&Bond	
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			Middletown, CT 06457 (860) 704-4760	
	<u>18" SANITARY</u>	SS		
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DATA TABLE - PROXIMATELY ¹ / ₂ ACRE			* PEN.0027217	
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MENT	EXISTING	PROPOSED		
)II	VARIES	PROJECT EXCEEDS 50'-0"	Project Title:	
)")"	VARIES	90'± PROJECT EXCEEDS 25'-0"	CENTER FOR INNOVATION AND ACTIVE CITIZENSHIP	
)	*30.30%	30.96%	SPECIAL PERMIT	
RE FEET	N/A *866'-0"	13,024 SQUARE FEET *866'-0"		
GHT: 35'-0" AL HEIGHT:40'-0"	N/A	MEAN HEIGHT: 35'-0" TOTAL VERTICAL HEIGHT: 40'-0"	THE FREDERICK GUNN SCHOOL 99 Green Hill Road Washington CT 06793	
DM AVERAGE G GRADE)	N/A	(MEASURED FROM AVERAGE PRE-EXISTING GRADE)	Washington, CT 06793	
ATS IN AUDITORIUM ATS IN AUDITORIUM *146 SPACES 138 SPACES		146 SPACES	Drawing Title: GENERAL NOTES,	
1 VAN SPACE) *5 SPACES (INC. 1 VAN SPA		E) *5 SPACES (INC. 1 VAN SPACE) ABBREVIATIONS, LE		
DR 24'-0"± WITHIN PROJECT OF WORK		24'-0"± WITHIN PROJECT LIMIT OF WORK	AND LOCATION MAP	
λ) λ)			Project No: 08323.00 Scale: AS SHOWN	
			Drawn By: AVC Checked By: KMM	
			Approved By: CJC Date: 01/24/22	

Drawing N





SITE UTILITY DEMOLITION PLAN NOTES

- 1. UTILITY, STRUCTURE AND FACILITY LOCATIONS SHOWN HEREON WERE PLOTTED FROM INFORMATION SUPPLIED BY RESPECTIVE UTILITY COMPANIES AND DATA OBTAINED FROM FIELD SURVEYS AND AS-BUILT DRAWINGS. THE ACCURACY AND COMPLETENESS OF SUBSURFACE INFORMATION SHOWN ON THESE DRAWINGS IS NOT GUARANTEED. THE CONTRACTOR SHALL DETERMINE FOR HIMSELF, THE LOCATIONS AND ELEVATIONS OF ALL UTILITIES WHICH MAY AFFECT HIS CONSTRUCTION OPERATIONS. THE CONTRACTOR MUST ADEQUATELY PROTECT AND SUPPORT UTILITIES AND HE SHALL BE RESPONSIBLE FOR ALL DAMAGE INCURRED AT NO EXPENSE TO THE OWNER. ANYONE USING UTILITY INFORMATION AND DATA PROVIDED HEREIN SHALL CONTACT "CALL BEFORE YOU DIG", 1-800-922-4455 OR WWW.CBYD.COM, 72 HOURS IN ADVANCE TO VERIFY THE LOCATION OF UTILITIES PRIOR TO STARTING CONSTRUCTION.
- 2. REFERENCE IS MADE TO PLAN ENTITLED TOPOGRAPHIC SURVEY SCIENCE BUILDING PROJECT THE FREDERICK GUNN SCHOOL, 22 KIRBY ROAD, WASHINGTON, CT" DATED MAY 18, 2021, LATEST REVISION DECEMBER 14, 2021. PREPARED BY SMITH & COMPANY SURVEYORS & ENGINEERS, INC. 247 MAIN STREET SOUTH, WOODBURY, CT.
- 3. THE CONTRACTOR SHALL OBTAIN A TOWN OF WASHINGTON EXCAVATION PERMIT PRIOR TO ANY WORK BEING PERFORMED WITHIN TOWN RIGHT-OF-WAY.
- 4. ANY AND ALL WORK PERFORMED ON THE TOWN OF WASHINGTON RIGHT-OF-WAY SHALL BE REQUIRED TO MEET THE TOWN STANDARDS
- 5. THE CONTRACTOR SHALL TAKE EXTREME CARE TO PROTECT ALL EXISTING STRUCTURES, SURFACE IMPROVEMENTS, LANDSCAPING, ETC. OUTSIDE THE PROJECT LIMIT LINE AND SHALL RESTORE ANY DAMAGE TO THESE ITEMS TO PRE-DAMAGE CONDITION OR BETTER.
- 6. CONTRACTOR SHALL SAWCUT EXISTING PAVEMENT AND SIDEWALK AREAS AS REQUIRED BY THE CONTRACT DRAWINGS OR THE OWNER'S REPRESENTATIVE PRIOR TO THE START OF ANY EXCAVATION AND AT ALL LOCATIONS WHERE THE PROPOSED PAVEMENT/CONCRETE WALK MEET EXISTING PAVEMENT/CONCRETE WALK.
- 7. CONTRACTOR TO DEMOLISH, REMOVE, AND LEGALLY DISPOSE OF MISCELLANEOUS POLES, BIT CONC PAVEMENT, CONCRETE WALK, SEWER, STORM, CURBING, CONCRETE FOUNDATIONS, SITE SIGNAGE NOT CALLED OUT TO BE REUSED, ETC. AND ALL ITEMS INDICATED TO BE REMOVED WITHIN THE PROJECT LIMIT LINE.
- 8. THE CONTRACTOR SHALL PROTECT EXISTING UTILITY STRUCTURES NOT IDENTIFIED FOR REMOVAL DURING UTILITY AND SURFACE DEMOLITION OPERATIONS. THE CONTRACTOR SHALL BE RESPONSIBLE FOR ANY DAMAGE INCURRED TO EXISTING UTILITY STRUCTURES AND SHALL REPAIR OR REPLACE THE EXISTING UTILITY STRUCTURES TO PRE-DAMAGED CONDITION OR BETTER TO THE SATISFACTION OF THE OWNER AND AT NO ADDITIONAL COST TO THE OWNER.
- 9. THE PLAN IS PROVIDED TO SHOW THE GENERAL EXTENT OF THE SITE UTILITY REMOVAL AND DEMOLITION. NOT ALL ITEMS REQUIRING REMOVAL MAY BE SHOWN OR CALLED OUT. THE CONTRACTOR IS RESPONSIBLE TO REMOVE AND PROPERLY DISPOSE OF ALL ITEMS ON THE SITE (ABOVE GROUND OR BELOW GROUND) WHICH ARE NOT REQUIRED TO BE SAVED OR PROTECTED AND WHICH WILL NOT BE INCORPORATED INTO THE FINAL CONSTRUCTION.
- 10. UNLESS OTHERWISE NOTED ON THE PLANS, REMOVAL OF EXISTING BITUMINOUS CONCRETE PAVEMENT SHALL INCLUDE REMOVAL OF THE PAVEMENT BASE COARSE, AND ALL ADJACENT CURBING.
- 11. THE PROVISIONS OF WORKER SAFETY AND/OR HEALTH PROTOCOLS THAT ADDRESS COMPLIANCE WITH THE RULES, LAWS AND REGULATIONS PERTAINING TO CONSTRUCTION SAFETY AND/OR THE POTENTIAL AND/OR ACTUAL RISK OF EXPOSURE TO SITE SPECIFIC PHYSICAL OR CHEMICAL HAZARDS POSED TO THE CONTRACTOR'S EMPLOYEES IS SOLELY THE RESPONSIBILITY OF THE CONTRACTOR. REFER TO APPLICABLE HEALTH AND SAFETY SPECIFICATIONS
- 12. PRIOR TO DEMOLITION WORK OF ANY UTILITY COMPANY, THE CONTRACTOR SHALL CONTACT THE RESPECTIVE UTILITY COMPANY. THE CONTRACTOR SHALL COORDINATE ANY REMOVAL OF EXISTING UTILITIES WITH THE RESPECTIVE UTILITY COMPANY.
- 13. CONTRACTOR SHALL PROTECT ALL EXISTING UTILITIES NOT IDENTIFIED FOR REMOVAL OR ABANDONMENT. COORDINATE WITH PROPOSED UTILITY AND STORMWATER MANAGEMENT WORK, SEE SHEETS C-101 AND C-102.
- 14. ACTUAL SAWCUT LIMITS, PAVEMENT/CONCRETE REMOVAL AND REPLACEMENT, SHALL BE DETERMINED IN THE FIELD PRIOR TO CONSTRUCTION. SAWCUT, REMOVAL, AND REPLACEMENT LIMITS SHALL COINCIDE WITH THE NEAREST JOINT IN CONCRETE WALK REQUIRED TO INSTALL THE PROPOSED WORK.
- 15. ALL ITEMS IDENTIFIED FOR REMOVAL/DEMOLITION SHALL BE DISPOSED OF LEGALLY OFF-SITE. ALL COSTS SHALL BE INCLUDED IN THE LUMP SUM BID PRICE.
- 16. CONTRACTOR TO COMPLY WITH THE REQUIREMENTS FOR EROSION AND SEDIMENTATION CONTROL, SEE C-201 AND C-202.
- 17. THE CONTRACTOR SHALL MAINTAIN SANITARY SEWER FLOWS BY PUMPING OR OTHER MEANS APPROVED BY THE OWNER'S REPRESENTATIVE DURING CONSTRUCTION OF THE PROPOSED SANITARY SEWER IN LOCATIONS WHERE SEWERS ARE BEING INSTALLED, REPLACED OR RELOCATED.

SITE UTILITY DEMOLITION PLAN LEGEND:

REMOVE EXISTING UTILITY STRUCTURE/TREE

ABANDON STRUCTURE

CUT AND CAP PIPE

PROJECT LIMIT LINE

TEST PIT

ABANDON EXISTING UTILITY PIPE

REMOVE EXISTING UTILITY PIPE



Tighe&Bond

213 Court Street Suite 1100 Middletown, CT 06457 (860) 704-4760

No.DescriptionIDWG ISSUE & REVISION HISTORY





Date

Project Title:

Stamp

CENTER FOR INNOVATION AND ACTIVE CITIZENSHIP SPECIAL PERMIT

THE FREDERICK GUNN SCHOOL 99 Green Hill Road Washington, CT 06793

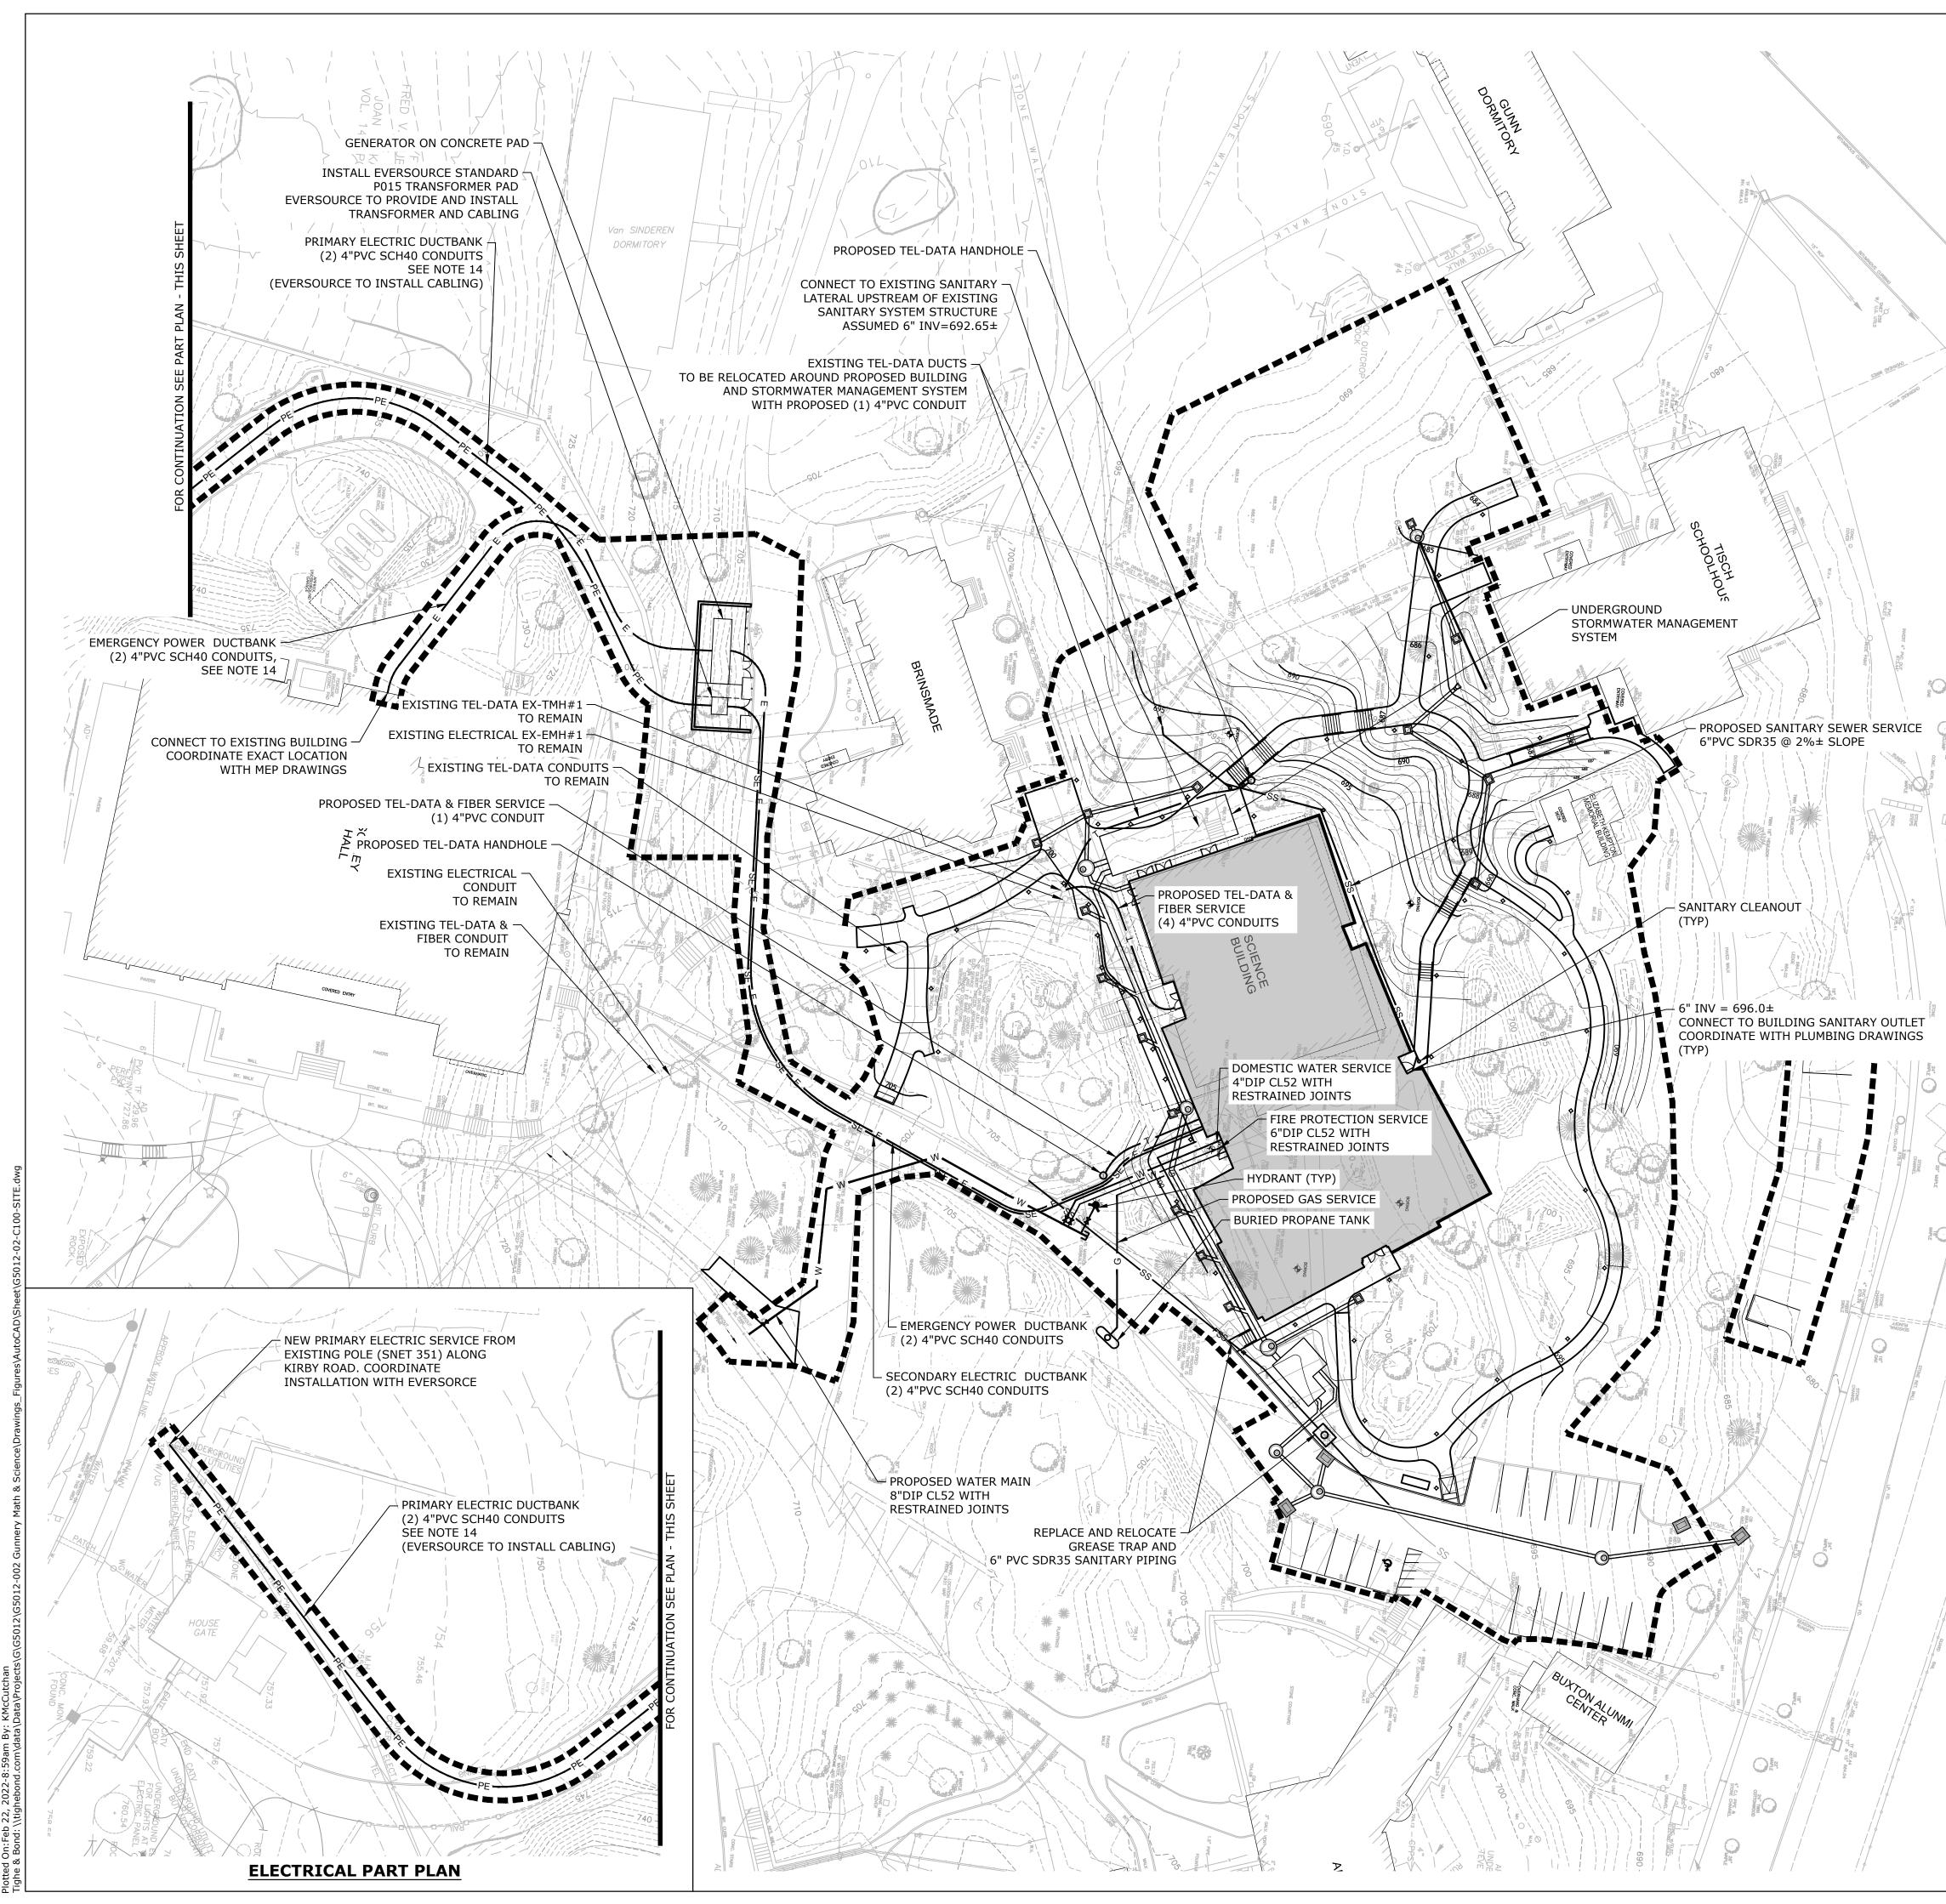
Drawing Title:

SITE UTILITY DEMOLITION PLAN

Project No:	08323.00	Scale:	1" = 30'
Drawn By:	AVC		
Checked By:	КММ		
Approved By:	CJC		
Date:	01/24/22		

C-011

Drawing No.



SITE DRAINAGE AND UTILITY PLAN NOTES

- 1. UTILITY, STRUCTURE AND FACILITY LOCATIONS SHOWN HEREON WERE PLOTTED FROM INFORMATION SUPPLIED BY RESPECTIVE UTILITY COMPANIES AND DATA OBTAINED FROM FIELD SURVEYS AND AS-BUILT DRAWINGS. THE ACCURACY AND COMPLETENESS OF SUBSURFACE INFORMATION SHOWN ON THESE DRAWINGS IS NOT GUARANTEED. THE CONTRACTOR SHALL DETERMINE FOR HIMSELF, THE LOCATIONS AND ELEVATIONS OF ALL UTILITIES WHICH MAY AFFECT HIS CONSTRUCTION OPERATIONS. THE CONTRACTOR MUST ADEQUATELY PROTECT AND SUPPORT UTILITIES AND HE SHALL BE RESPONSIBLE FOR ALL DAMAGE INCURRED AT NO EXPENSE TO THE OWNER. ANYONE USING UTILITY INFORMATION AND DATA PROVIDED HEREIN SHALL CONTACT "CALL BEFORE YOU DIG", 1-800-922-4455 OR WWW.CBYD.COM, 72 HOURS IN ADVANCE TO VERIFY THE LOCATION OF UTILITIES PRIOR TO STARTING CONSTRUCTION.
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- THE CONTRACTOR SHALL OBTAIN A TOWN OF WASHINGTON EXCAVATION PERMIT PRIOR TO ANY WORK BEING PERFORMED WITHIN TOWN RIGHT-OF-WAY.
- ANY AND ALL WORK PERFORMED ON THE TOWN OF WASHINGTON RIGHT-OF-WAY SHALL BE REQUIRED TO MEET THE TOWN STANDARDS.
- 5. THE LOCATIONS OF ITEMS NOT DIMENSIONED ON THE DRAWINGS SHALL BE FIELD STAKED BY THE CONTRACTOR AND THEIR LOCATIONS APPROVED BY THE OWNER'S REPRESENTATIVE PRIOR TO INSTALLATION.
- 6. THE CONTRACTOR SHALL COORIDINATE/VERIFY THE EXACT SIZES LOCATIONS, ELEVATIONS, OF ALL PROPOSED BUILDING'S UTILITY SERVICES WITH THE PROJECT MECHANICAL, ELECTRICAL AND PLUMBING DRAWINGS PRIOR TO ANY CONSTRUCTION OPERATIONS.
- 7. THE CONTRACTOR SHALL COORDINATE HIS WORK WITH THE WORK DONE BY THE RESPECTIVE UTILITY COMPANIES.
- 8. INSTALL CLEANOUT TO GRADE 5' OFF FACE OF BUILDING ON ALL SANITARY LATERALS.
- THE MANHOLE FRAME AND COVER SHALL BE CENTERED ON THE PRECAST OPENING. UNDER NO CIRCUMSTANCES WILL AN OFFSET FRAME AND COVER BE ACCEPTABLE. PRIOR TO FINAL PAVING, THE CONTRACTOR SHALL CHECK ALL MANHOLE STRUCTURES TO ASSURE THE FRAME AND COVER IS CENTERED ON THE PRECAST OPENING PRIOR TO FINAL PAVING OR SURFACE TREATMENT INSTALLATION. THE CONTRACTOR WILL BE RESPONSIBLE FOR ALL WORK REQUIRED TO CENTER FRAME AND COVER.
- 10. INSTALL "FERNCO" STYLE FLEXIBLE COUPLINGS AT ALL LOCATIONS WHERE JOINING PIPES OF DIFFERENT MATERIALS AND/OR SIZES PER MANUFACTURER'S RECOMMENDATIONS.
- 11. THE CONTRACTOR SHALL MAINTAIN EXISTING SANITARY SEWER FLOWS BY PUMPING OR OTHER MEANS APPROVED BY THE OWNER'S REPRESENTATIVE DURING CONSTRUCTION OF THE PROPOSED SANITARY SEWER IN LOCATIONS WHERE SANITARY SEWER ARE BEING INSTALLED, REPLACED OR RELOCATED.
- 12. SITE ELECTRICAL, EMERGENCY POWER, TEL-DATA, AND CABLE SERVICES ARE SHOWN FOR COORDINATION PURPOSES ONLY. FOR DESIGN AND SPECIFICATIONS OF THESE SERVICES INCLUDING ALL WIRING, EQUIPMENT, CONDUITS, HANDHOLES, MANHOLES, TESTING AND ACCEPTANCE, ETC. SEE PROJECT MECHANICAL/ELECTRICAL/PLUMBING DRAWINGS AND SPECIFICATIONS.
- 13. SITE ELECTRICAL WORK SHALL CONFORM TO EVERSOURCE ENERGY STANDARDS AND REQUIREMENTS. CONTRACTOR SHALL COORDINATE ALL WORK WITH THE SCHOOL AND EVERSOURCE.
- 14. DISTURBED AREAS FOR INSTALLATION OF ELECTRICAL CONDUITS OUTSIDE OF THE LIMIT OF RESTORATION AS SHOWN ON THE LANDSCAPE DRAWINGS SHALL BE REPLACED-IN-KIND, RETURNED TO THEIR ORIGINAL CONDITION OR BETTER AS DIRECTED BY THE OWNER'S REPRESENTATIVE.



Project Title:

No.

Stamp

CENTER FOR INNOVATION AND ACTIVE CITIZENSHIP SPECIAL PERMIT

Description

DWG ISSUE & REVISION HISTORY

Date

THE FREDERICK GUNN SCHOOL 99 Green Hill Road Washington, CT 06793

Drawing Title:

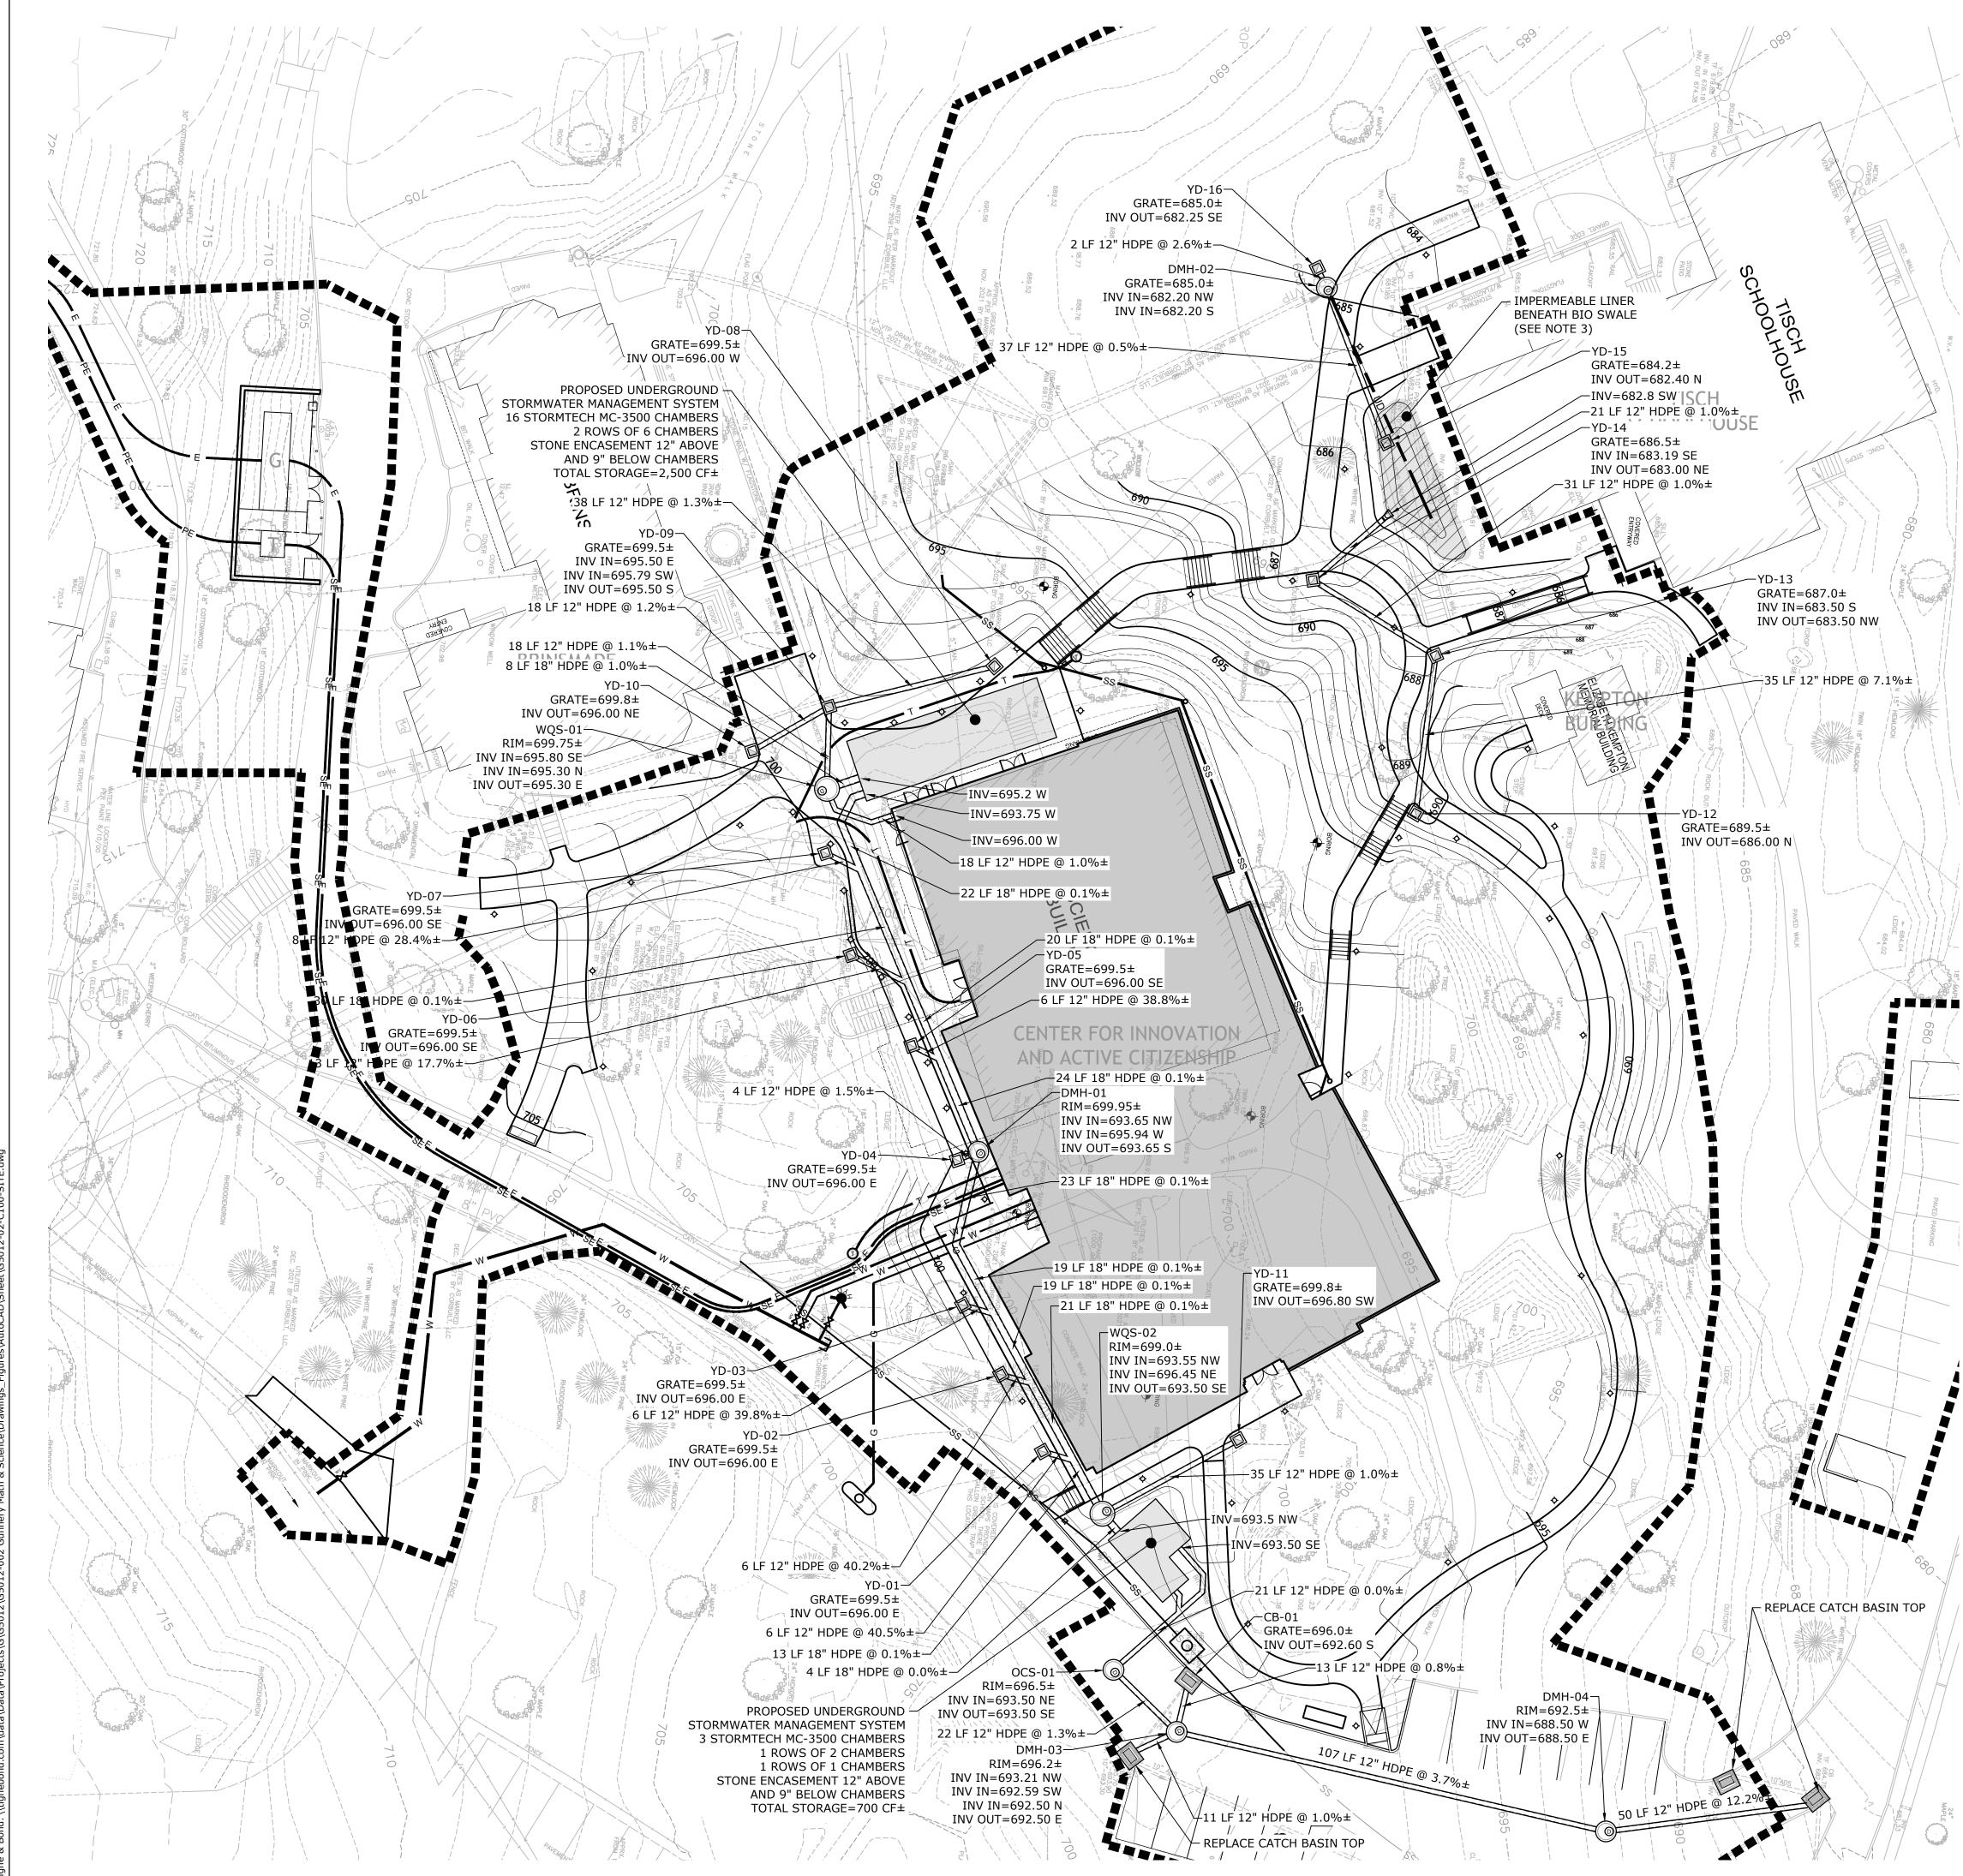
SITE UTILITY PLAN

Project No: 08323.00 Scale: 1" = 30' Drawn By: AVC Checked By: KMM Approved By: CJC Date: 01/24/22

C-101

Drawing No.

SCALE: 1" = 30'



arou: 1/12/222 1 On:Feb 22, 2022-8:54am By: KMcCutchan 2 Don:Feb 22, 2022-8:54am 2020 Anti-North Dissionary Contract Marth 8. Editor 2010 Anti-CAD/Charty CE013 23 C100

SITE STORMWATER MANAGEMENT PLAN NOTES

- 1. UTILITY, STRUCTURE AND FACILITY LOCATIONS SHOWN HEREON WERE PLOTTED FROM INFORMATION SUPPLIED BY RESPECTIVE UTILITY COMPANIES AND DATA OBTAINED FROM FIELD SURVEYS AND AS-BUILT DRAWINGS. THE ACCURACY AND COMPLETENESS OF SUBSURFACE INFORMATION SHOWN ON THESE DRAWINGS IS NOT GUARANTEED. THE CONTRACTOR SHALL DETERMINE FOR HIMSELF, THE LOCATIONS AND ELEVATIONS OF ALL UTILITIES WHICH MAY AFFECT HIS CONSTRUCTION OPERATIONS. THE CONTRACTOR MUST ADEQUATELY PROTECT AND SUPPORT UTILITIES AND HE SHALL BE RESPONSIBLE FOR ALL DAMAGE INCURRED AT NO EXPENSE TO THE OWNER. ANYONE USING UTILITY INFORMATION AND DATA PROVIDED HEREIN SHALL CONTACT "CALL BEFORE YOU DIG", 1-800-922-4455 OR WWW.CBYD.COM, 72 HOURS IN ADVANCE TO VERIFY THE LOCATION OF UTILITIES PRIOR TO STARTING CONSTRUCTION.
- 2. ALL ON-SITE STORM SEWER PIPES AND FITTINGS SPECIFIED AS HDPE SHALL BE ADS N-12 WT (WATERTIGHT) PIPE AS MANUFACTURED BY ADVANCED DRAINAGE SYSTEMS, HILLIARD, OHIO UNLESS OTHERWISE NOTED.
- 3. BIO SWALE IMPERMEABLE LINER SHALL CONSIST OF A PVC LINER INSTALLED BETWEEN A PROTECTIVE LAYER OF NON-WOVEN GEOTEXTILE UNDERLAYMENT AND OVERLAYMENT. THE PVC LINER SHALL BE 30 MILS THICK (MIN) AS SUPPLIED BY R.H. MOORE & ASSOCIATES, OR APPROVED EQUAL. THE LINER SHALL BE INSTALLED AS ONE CONTINUOUS SHEET, OR SEAMS SHALL BE WELDED/TAPPED PER MANUFACTURER'S RECOMMENDATIONS. GEOTEXTILE SHALL BE 0801T NONWOVEN GEOTEXTILE AS SUPPLIED BY ADS GEOSYNTHETICS, OR APPROVED EQUAL. THE CONTRACTOR SHALL TAKE PRECAUTION WHEN INSTALLING THE LINER, WHEN BACKFILLING ABOVE THE LINER, AND WHEN WORKING IN CLOSE PROXIMITY TO THE LINER AFTER INSTALLATION, IN ORDER TO PROTECT THE LINER FROM PUNCTURES OR OTHER DAMAGE. SEE PROJECT LANDSCAPE ARCHITECTURE DRAWINGS AND SPECIFICATIONS FOR BIO SWALE DETAILS.
- 4. SEE SHEET C-001 FOR GENERAL NOTES, AND SHEET C-101 FOR ADDITIONAL UTILITY NOTES.





Tighe&Bond 213 Court Street

Suite 1100 Middletown, CT 06457 (860) 704-4760

No. Description Date
DWG ISSUE & REVISION HISTORY
Stamp





Project Title:

CENTER FOR INNOVATION AND ACTIVE CITIZENSHIP SPECIAL PERMIT

THE FREDERICK GUNN SCHOOL 99 Green Hill Road Washington, CT 06793

Drawing Title:

SITE STORMWATER MANAGEMENT PLAN

 Project No:
 08323.00
 Scale:
 1" = 20'

 Drawn By:
 AVC

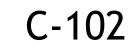
 Checked By:
 KMM

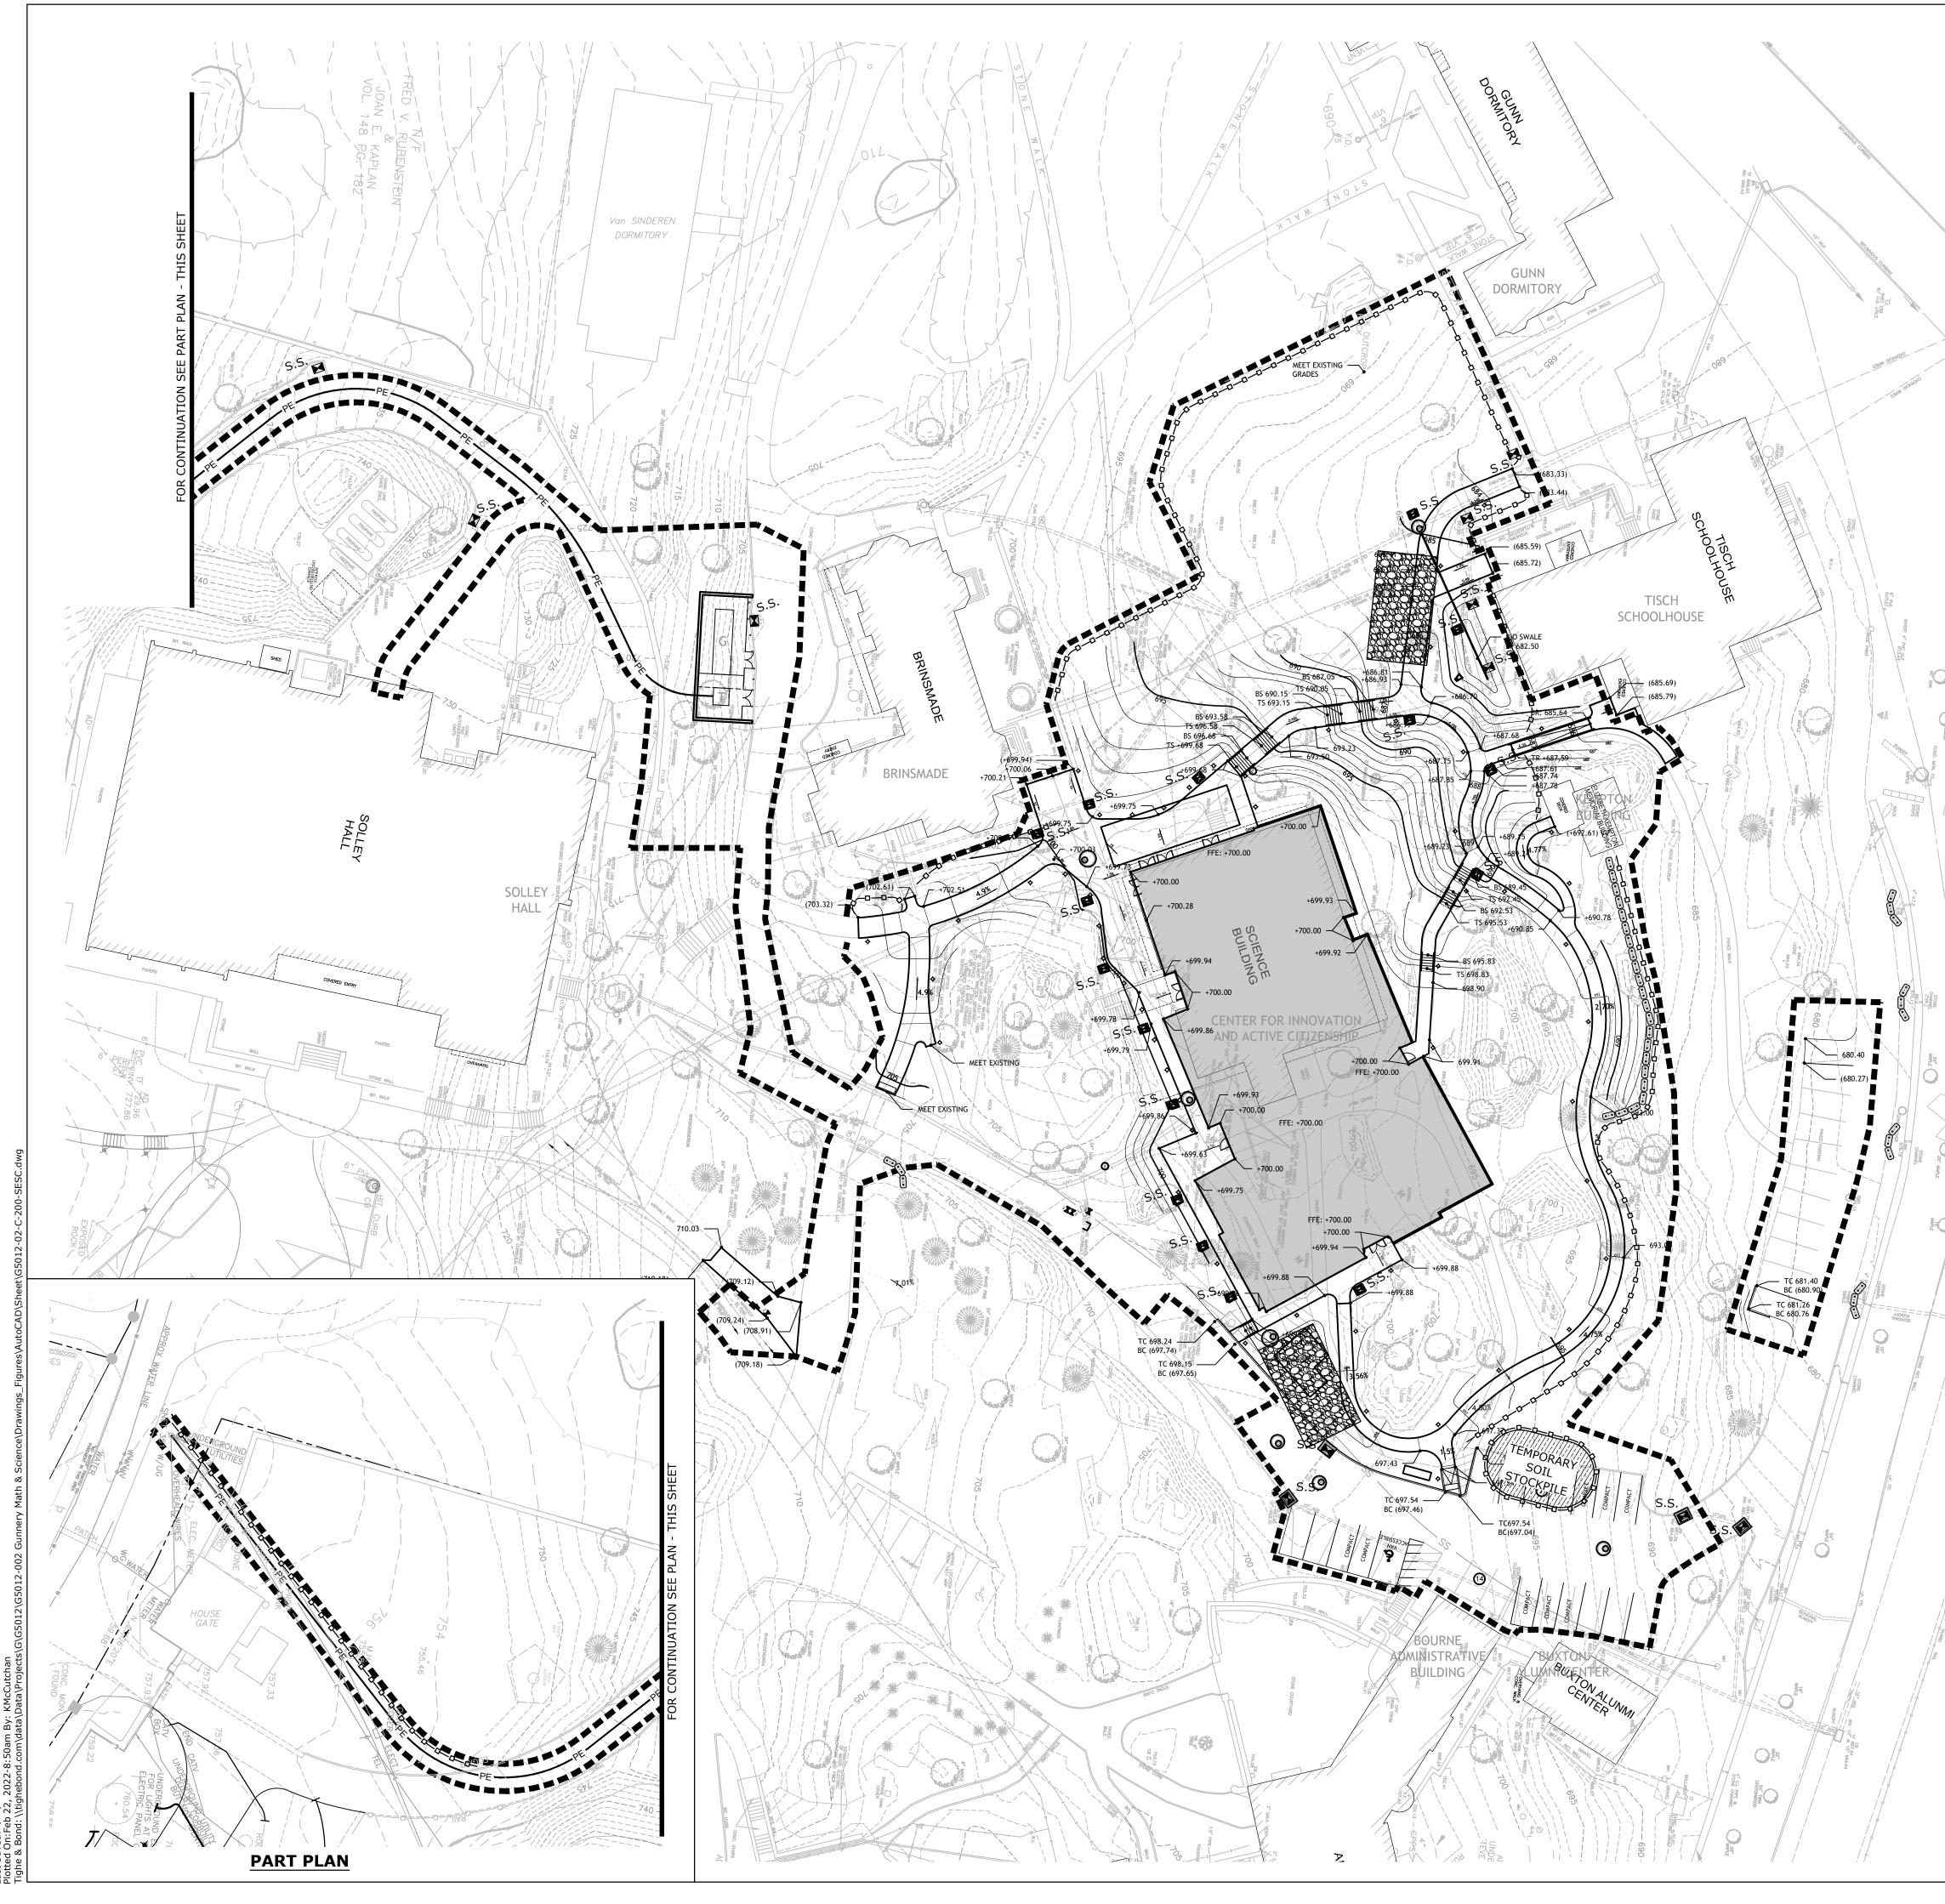
 Approved By:
 CJC

 Date:
 01/24/22

Drawing No.

SCALE: 1" = 20'

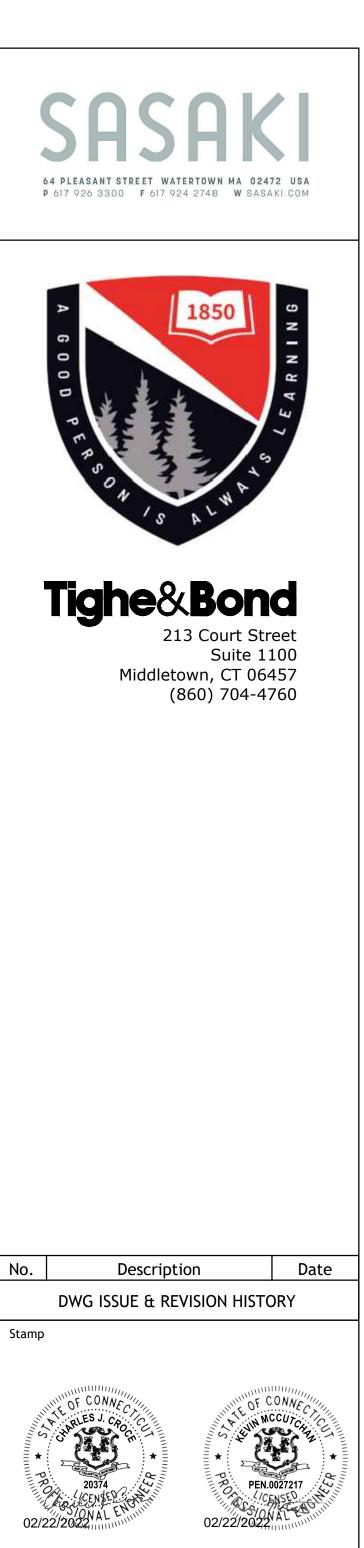




SOIL EROSION AND SEDIMENTATION CONTROL NOTES

- 1. UNDERGROUND UTILITIES, STRUCTURES AND FACILITY LOCATIONS DEPICTED HEREON HAVE BEEN COMPILED, IN PART, FROM RECORD MAPPING AND OTHER DATA SUPPLIED BY THE RESPECTIVE UTILITY COMPANIES, GOVERNMENTAL AGENCIES AND/OR OTHER SOURCES. THESE LOCATIONS MUST BE CONSIDERED APPROXIMATE IN NATURE. ADDITIONALLY, OTHER SUCH DATA MAY EXIST ON SITE, THE EXISTENCE OF WHICH ARE UNKNOWN TO TIGHE & BOND. THE EXISTENCE, SIZE AND LOCATION OF ALL SUCH FEATURES MUST BE DETERMINED AND VERIFIED IN THE FIELD BY APPROPRIATE AUTHORITIES PRIOR TO CONSTRUCTION @ CALL-BEFORE-YOU-DIG 1-800-922-4455.
- ALL SEDIMENTATION AND EROSION CONTROL MEASURES SHALL BE IN ACCORDANCE WITH THE STANDARDS AND SPECIFICATIONS OF THE "2002 CONNECTICUT GUIDELINES FOR SOIL EROSION AND SEDIMENT CONTROL" DEEP BULLETIN NO 34, AND ALL AMENDMENTS AND ADDENDA THERETO AS PUBLISHED BY THE CONNECTICUT DEPARTMENT OF ENERGY AND ENVIRONMENTAL PROTECTION.
- LAND DISTURBANCE SHALL BE KEPT TO THE MINIMUM NECESSARY FOR CONSTRUCTION.
- 4. ALL EROSION CONTROL MEASURES SHALL BE INSTALLED AS SHOWN ON THE PLANS AND ELSEWHERE AS ORDERED BY THE OWNER'S REPRESENTATIVE.
- ALL CATCH BASINS SHALL BE PROTECTED WITH SILT SACKS, HAYBALE RING, SILT FENCE OR BLOCK AND STONE INLET PROTECTION THROUGHOUT THE CONSTRUCTION PERIOD AND UNTIL ALL DISTURBED AREAS ARE THOROUGHLY STABILIZED.
- WHEREVER POSSIBLE, EROSION AND SEDIMENT CONTROL MEASURES SHALL BE INSTALLED PRIOR TO CONSTRUCTION.
- ADDITIONAL CONTROL MEASURES SHALL BE INSTALLED DURING CONSTRUCTION PERIOD AS ORDERED BY THE OWNER'S REPRESENTATIVE.
- 8. ALL SEDIMENTATION AND EROSION CONTROL MEASURES SHALL BE MAINTAINED IN EFFECTIVE CONDITION THROUGHOUT THE CONSTRUCTION PERIOD.
- 9. SEDIMENT REMOVED SHALL BE DISPOSED OF LEGALLY OFFSITE.
- 10. THE CONTRACTOR SHALL BE RESPONSIBLE FOR CONSTRUCTION AND MAINTENANCE OF ALL EROSION CONTROL MEASURES THROUGHOUT THE CONSTRUCTION PERIOD.
- 11. THE CONTRACTOR SHALL MAINTAIN A SUPPLY OF SILT FENCE/HAYBALES AND ANTI-TRACKING CRUSHED STONE ON-SITE FOR EMERGENCY REPAIRS.
- 12. THE CONTRACTOR SHALL UTILIZE APPROVED METHODS/MATERIALS FOR PREVENTING THE BLOWING AND MOVEMENT OF DUST FROM EXPOSED SOIL SURFACES ONTO ADJACENT PROPERTIES AND SITE AREAS.
- 13. ALL DRAINAGE STRUCTURES SHALL BE INSPECTED WEEKLY BY THE CONTRACTOR AND CLEANED TO PREVENT THE BUILD-UP OF SILT.
- 14. THE CONTRACTOR SHALL CAREFULLY COORDINATE THE PLACEMENT OF EROSION CONTROL MEASURES WITH THE PHASING OF CONSTRUCTION.
- 15. KEEP ALL PAVED ROADWAYS CLEAN. SWEEP BEFORE FORECASTED STORMS OR WEEKLY AS NECESSARY.
- 16. TREAT ALL UNPAVED SURFACES WITH 4" MINIMUM OF TOPSOIL AND SEEDING PRIOR TO FINAL STABILIZATION.
- 17. HAYBALE BARRIERS AND SILT FENCING SHALL BE INSTALLED ALONG THE TOE OF CRITICAL CUT AND FILL SLOPES AS SHOWN ON THE PLANS AND AS DIRECTED BY THE OWNER'S REPRESENTATIVE.
- 18. ALL TRUCKS LEAVING THE SITE MUST BE COVERED.
- 19. DISTURBED SLOPES SHALL BE TREATED WITH AN EROSION CONTROL SLURRY CONSISTING OF A MIXTURE OF WOOD FIBER MULCH, PLANT SEED AND 3 GALLONS/ACRE OF SILT STOP 640 LIQUID FLOCCULENT. THE FLOCCULENT IS PROVIDED BY HYDROGRASS TECHNOLOGIES, OXFORD MASSACHUSETTS.
- 20. ALL SEDIMENTATION AND EROSION CONTROLS SHALL BE CHECKED WEEKLY AND AFTER EACH RAINFALL EVENT. NECESSARY REPAIRS SHALL BE MADE WITHOUT DELAY.
- 21. PRIOR TO ANY FORECASTED RAINFALL, EROSION AND SEDIMENT CONTROLS SHALL BE INSPECTED AND REPAIRED AS NECESSARY.
- 22. AFTER ALL DISTURBED AREAS HAVE BEEN STABILIZED, EROSION CONTROLS MAY BE REMOVED ONCE AUTHORIZATION TO DO SO HAS BEEN SECURED FROM THE OWNER'S REPRESENTATIVE. DISTURBED AREAS SHALL BE SEEDED AND MULCHED.
- 23. ALL EMBANKMENT SLOPES 3:1 OR GREATER TO BE STABILIZED WITH EROSION CONTROL BLANKET, NORTH AMERICAN GREEN SC150BN OR APPROVED EQUIVALENT, UNLESS OTHERWISE NOTED ON THE PLANS.
- 24. ALL DRAINAGE SWALES SHALL BE STABILIZED WITH EROSION CONTROL BLANKET, NORTH AMERICAN GREEN C125BN OR APPROVED EQUIVALENT
- 25. CONTRACTOR IS TO COMPLY WITH THE REQUIREMENTS OF THE SOIL EROSION AND SEDIMENTATION CONTROL PLAN.
- 26. COORDINATE WITH LANDSCAPE PLANS FOR SITE DEMOLITION.
- 27. AREA OF SITE DISTURBANCE = 2.5 ACRES

SOIL EROSION AND SEDIMENT (CONTROL PLAN LEGEND
SILT SACK	S.S.
CONSTRUCTION ENTRANCE	
SILT FENCE	- <u>0-0-0-0-</u> 0-0-
HAYBALE BARRIER	
TEMPORARY SOIL STOCKPILE AREA	
	Ν



Project Title:

CENTER FOR INNOVATION AND ACTIVE CITIZENSHIP

SPECIAL PERMIT

THE FREDERICK GUNN SCHOOL 99 Green Hill Road Washington, CT 06793

Drawing Title:

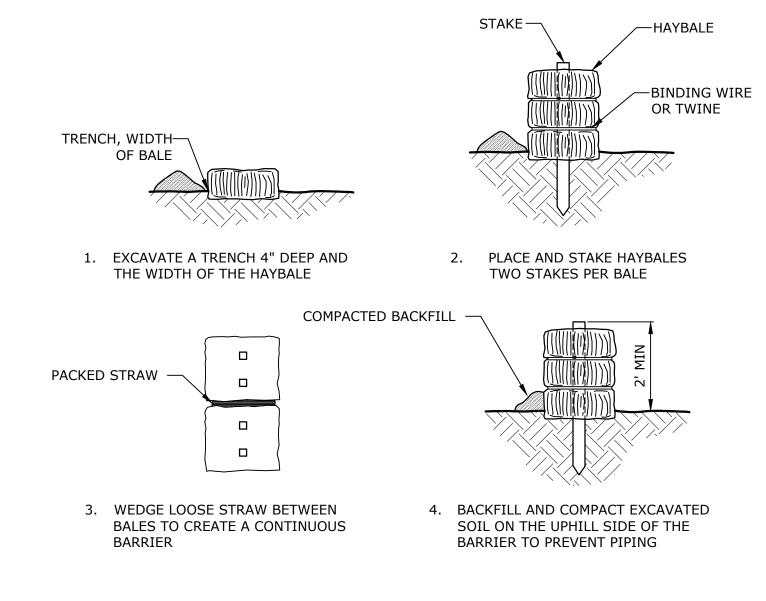
SOIL EROSION & SEDIMENTATION CONTROL PLAN

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Checked By:	КММ		
Approved By:	CJC		
Date:	01/24/22		

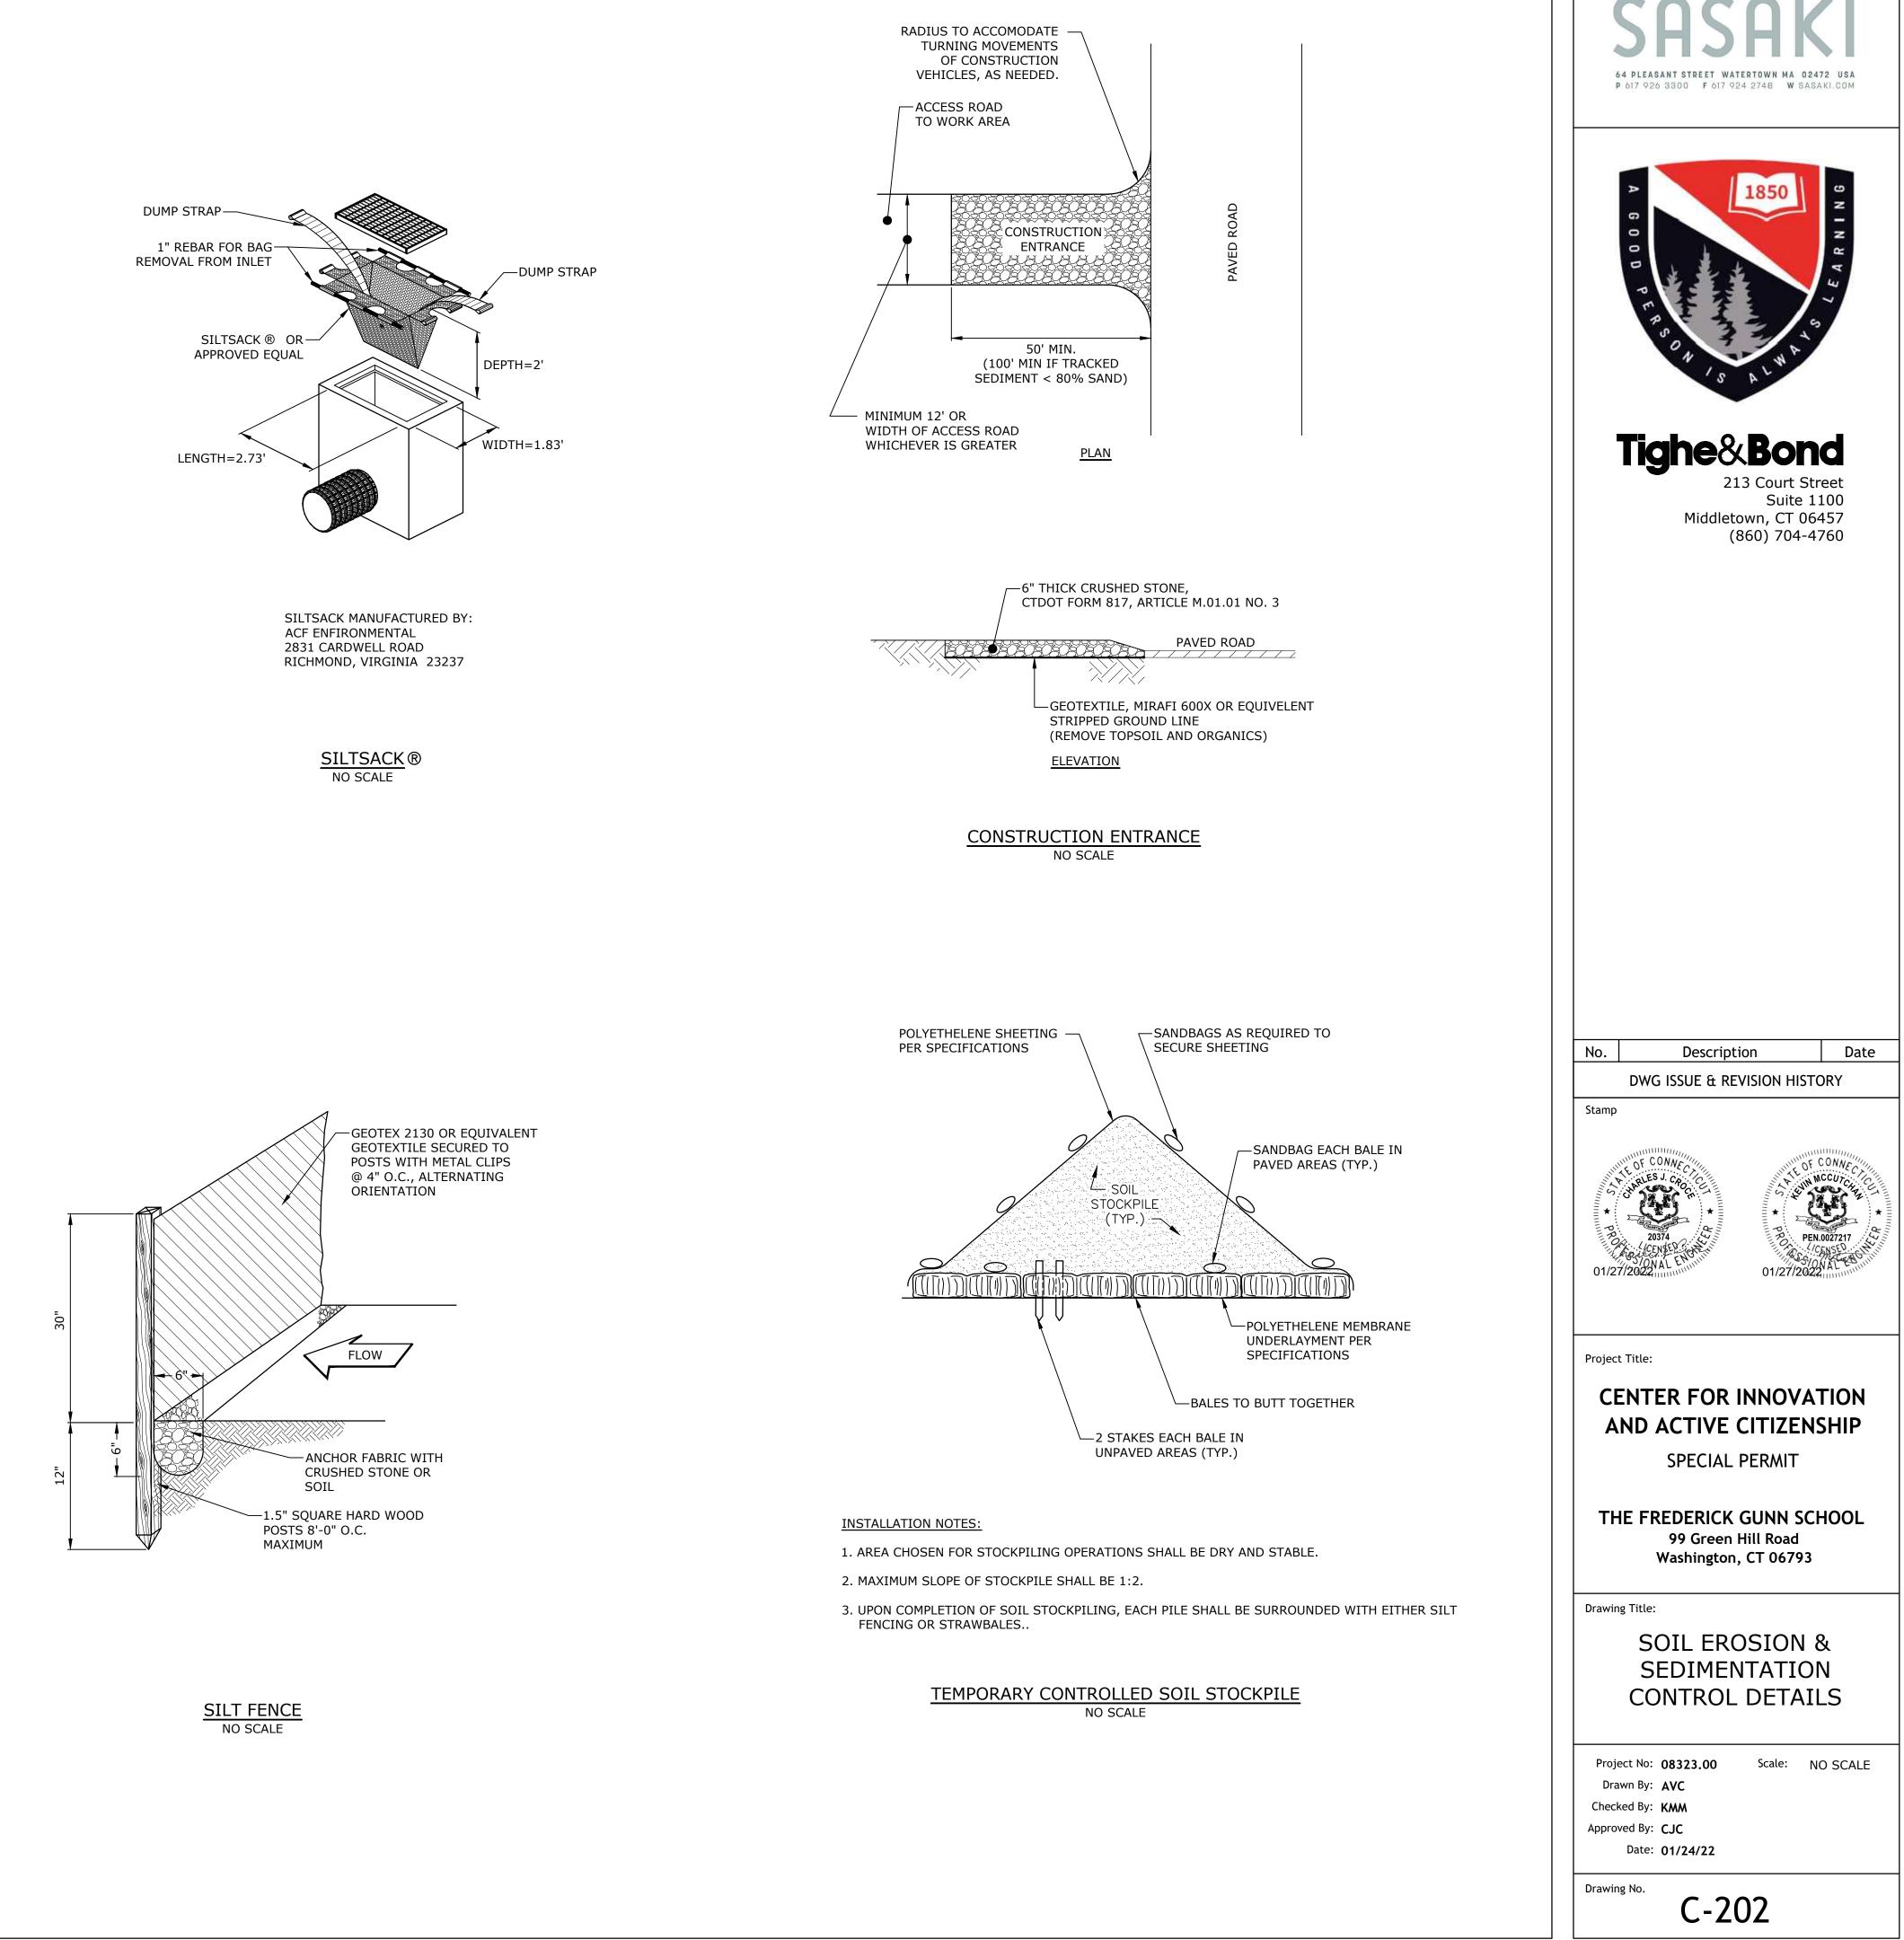
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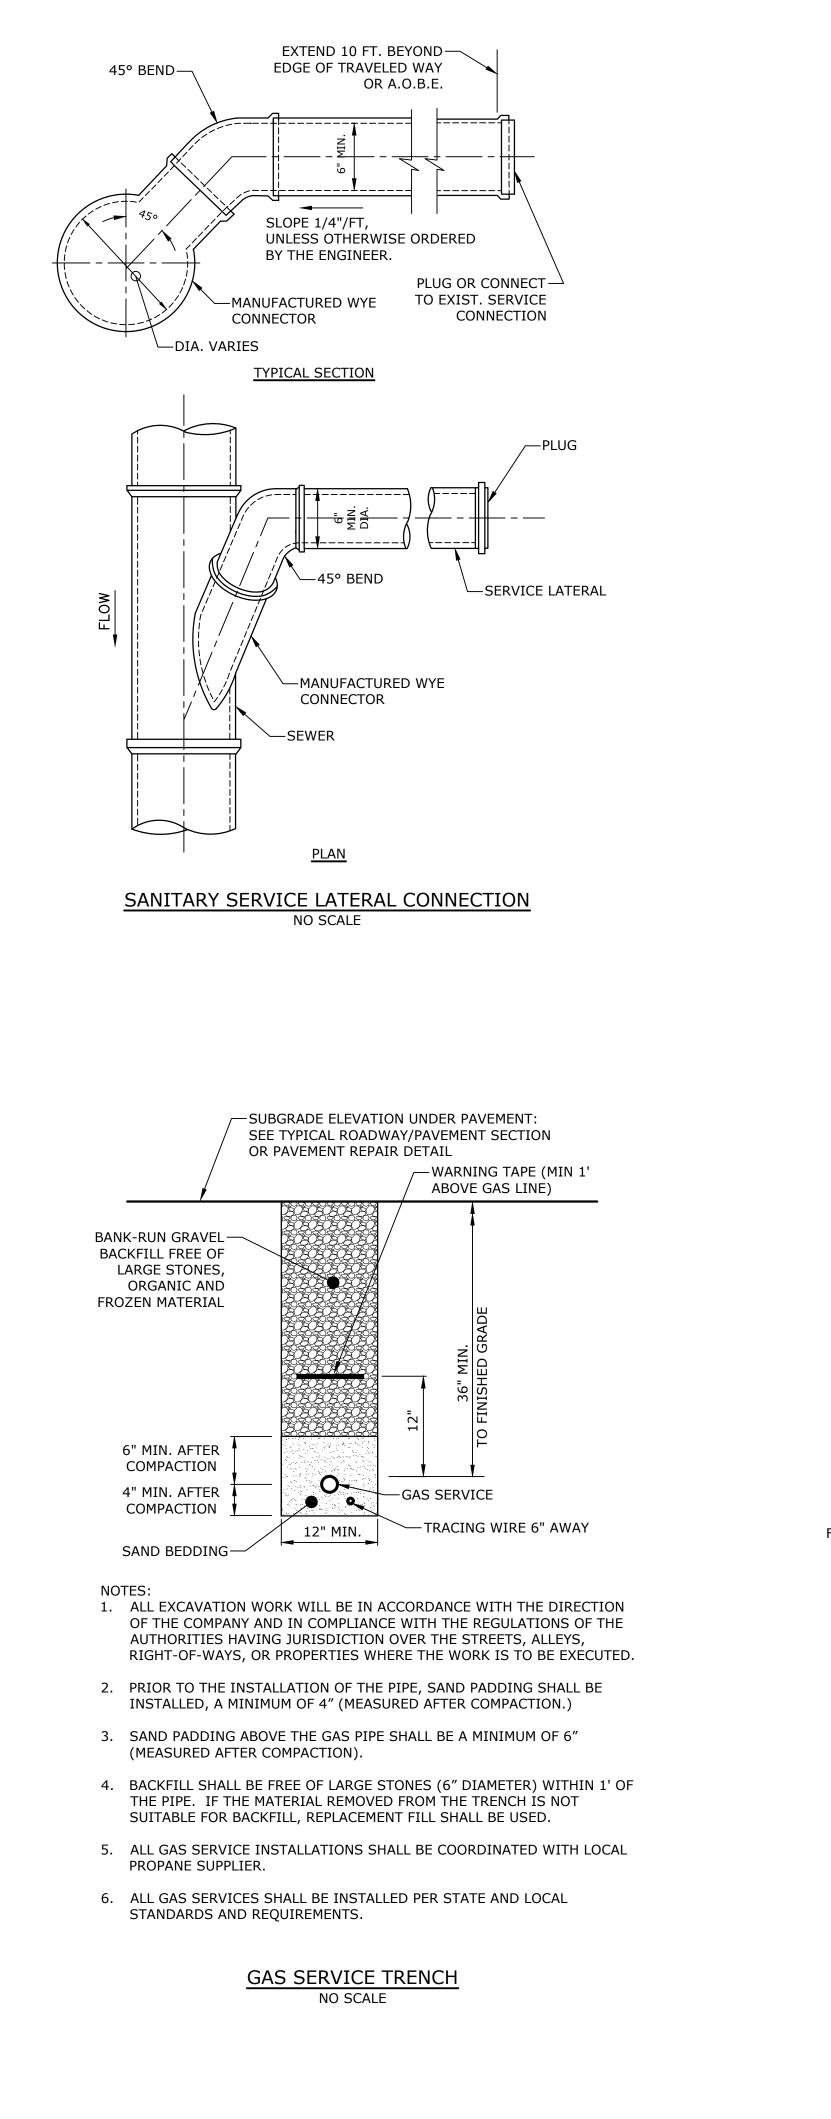
Drawing No.

SCALE: 1" = 30'



PLACEMENT AND CONSTRUCTION OF HAYBALE BARRIER NO SCALE



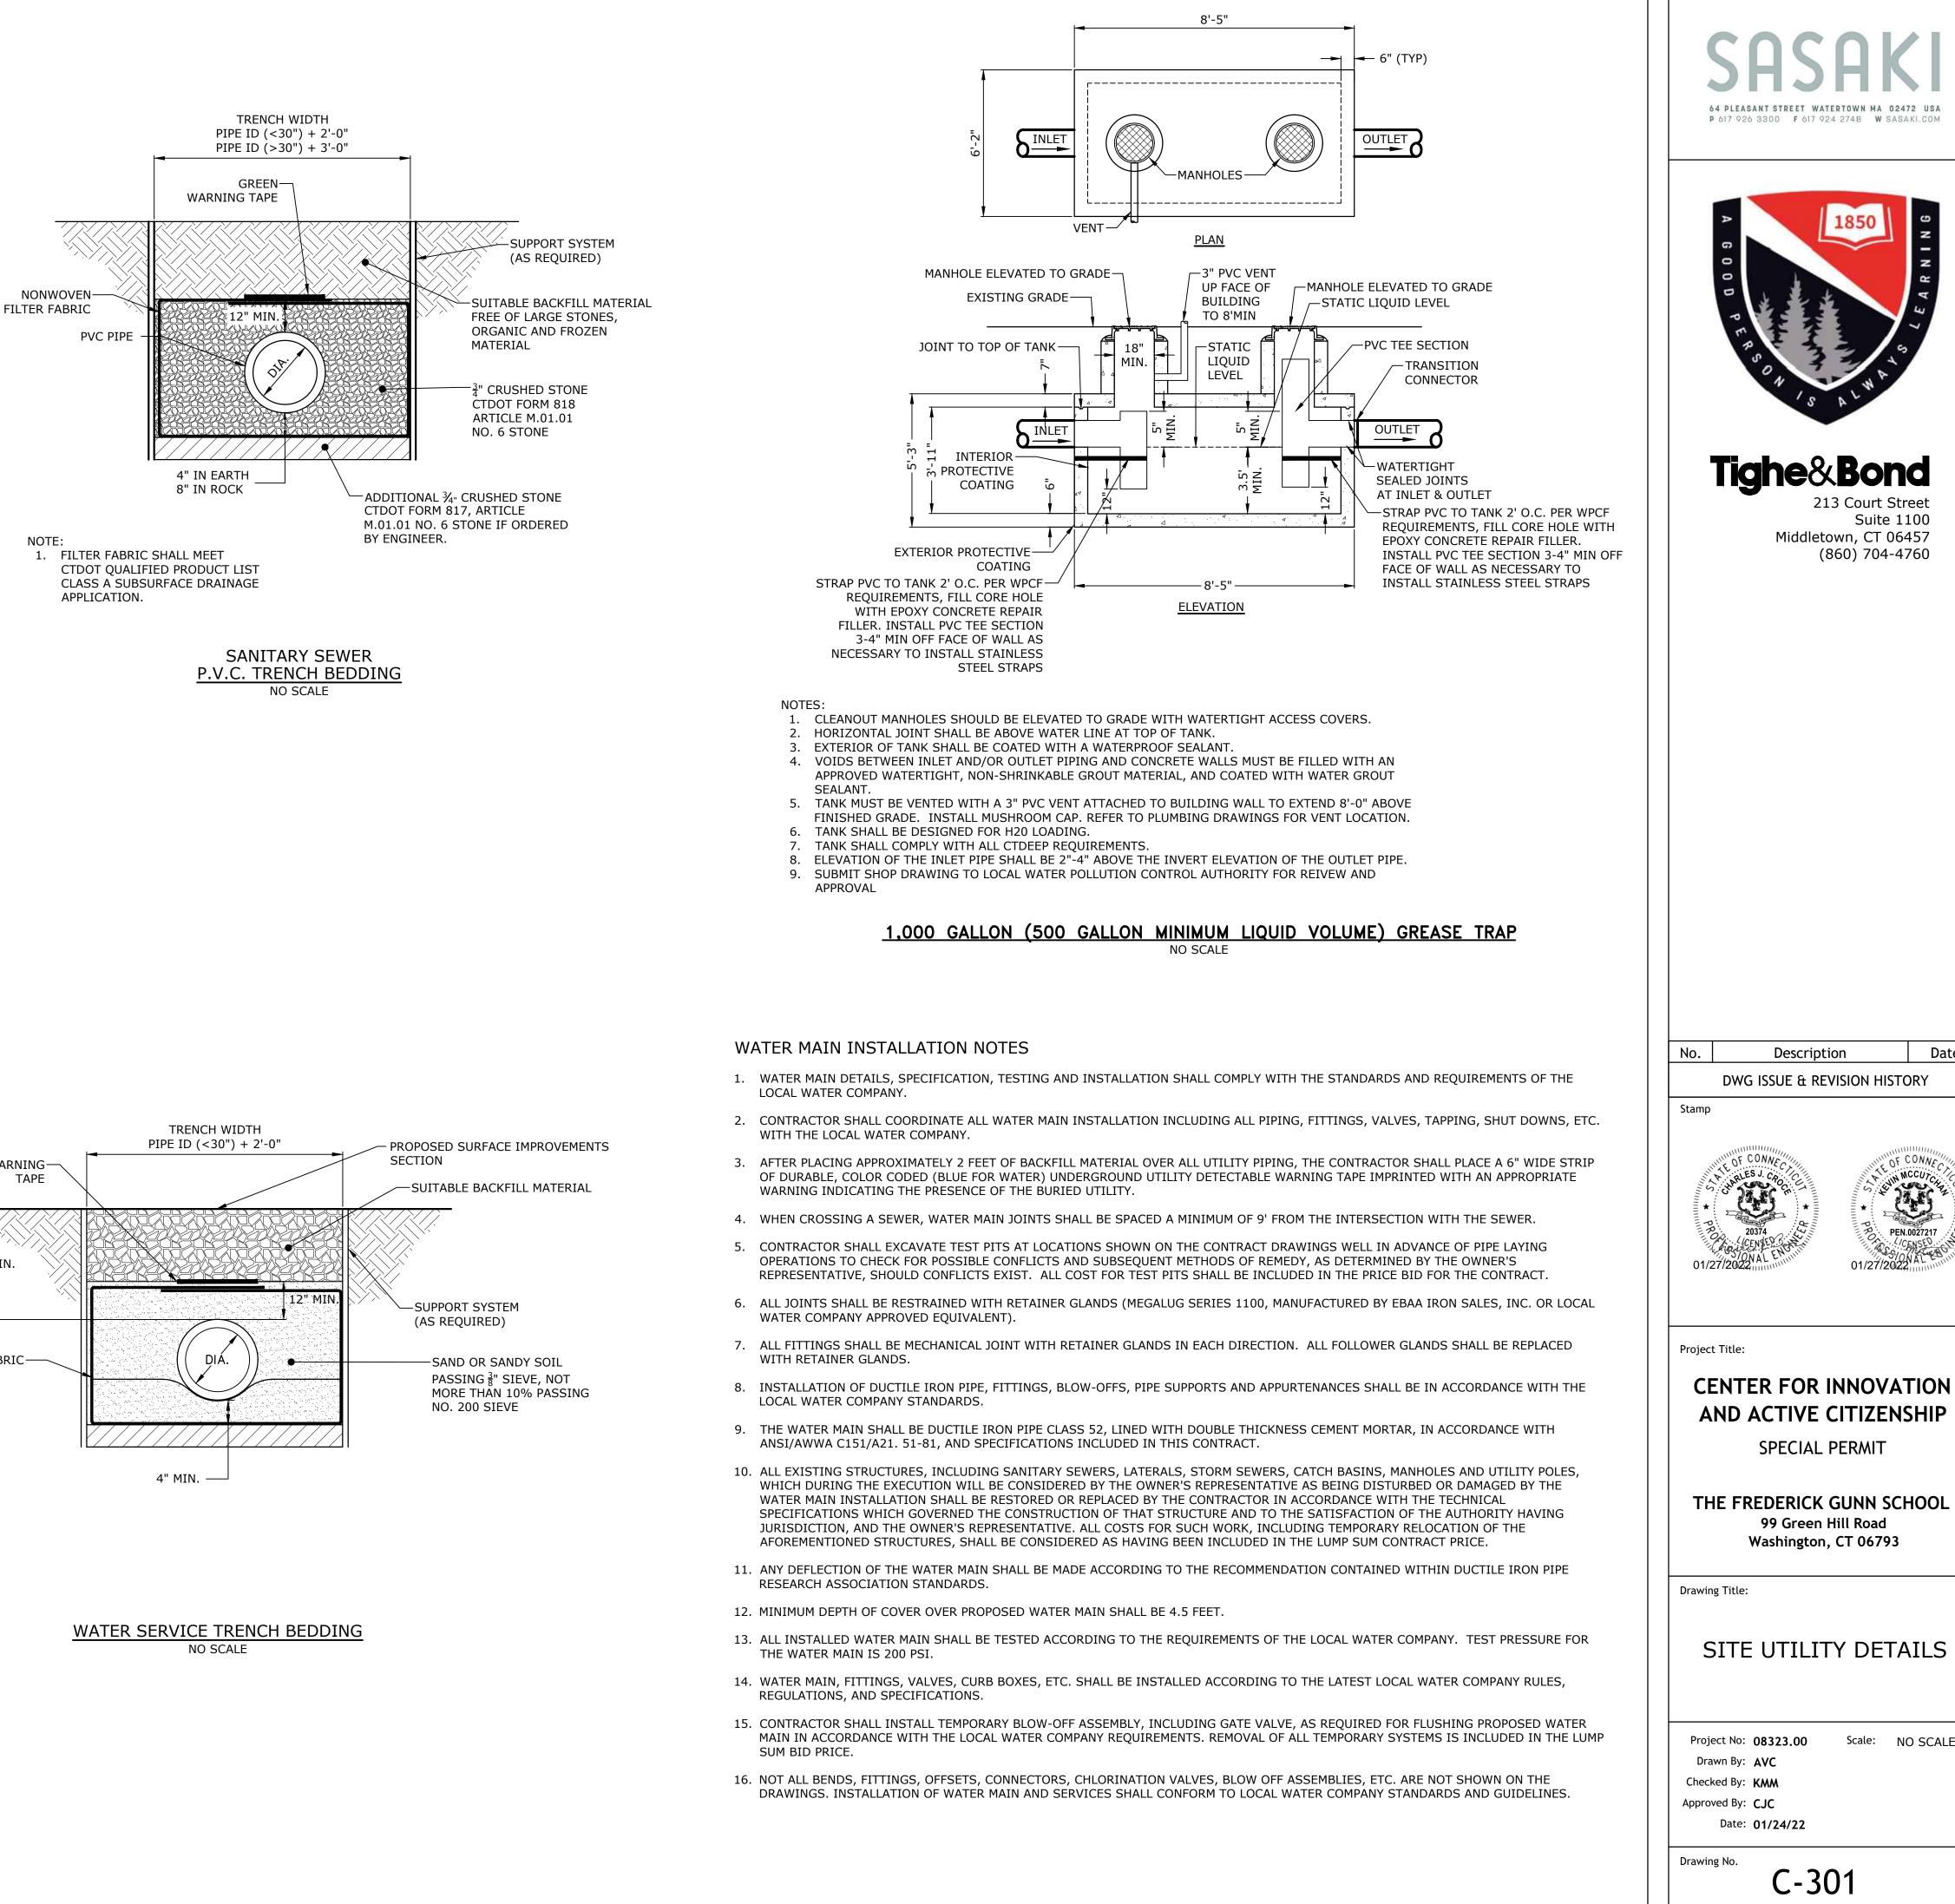


WARNING-

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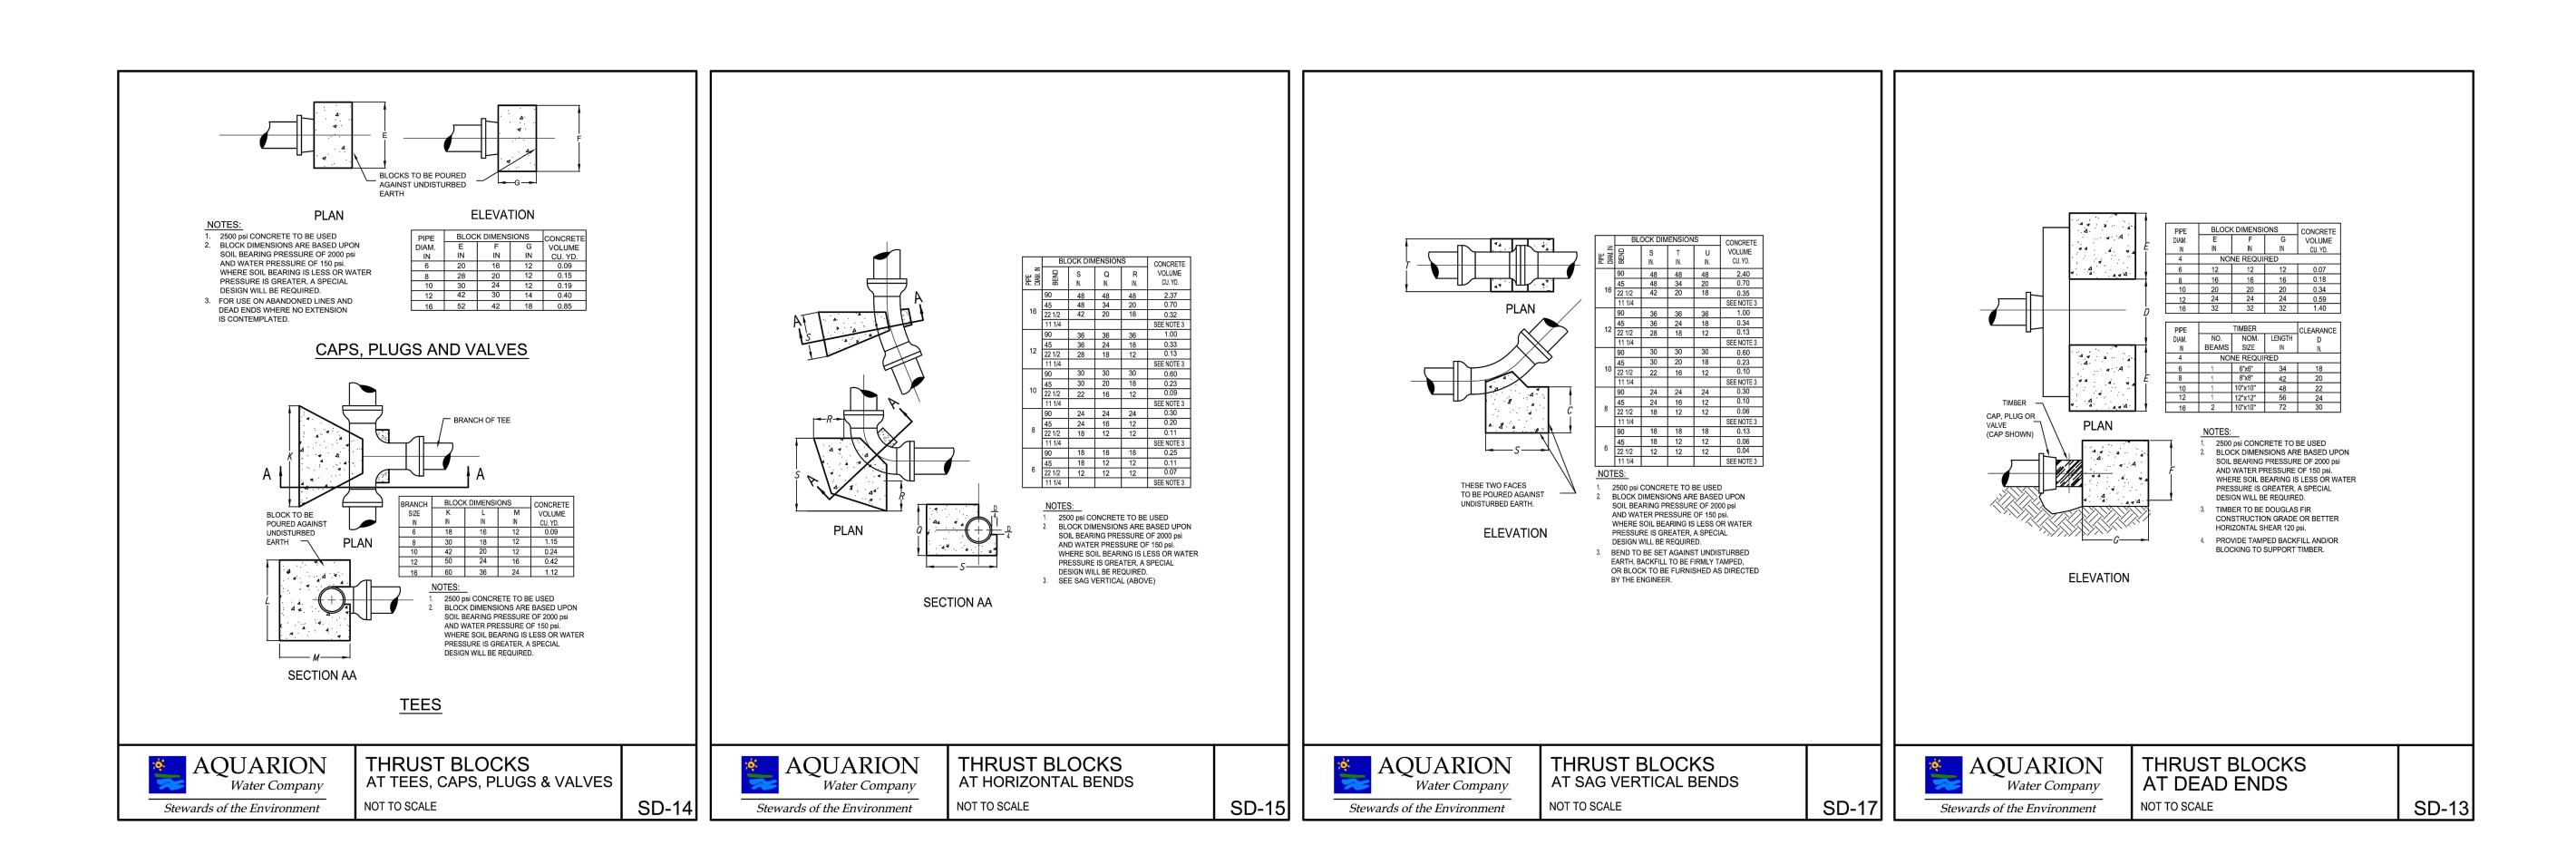
FILTER FABRIC-

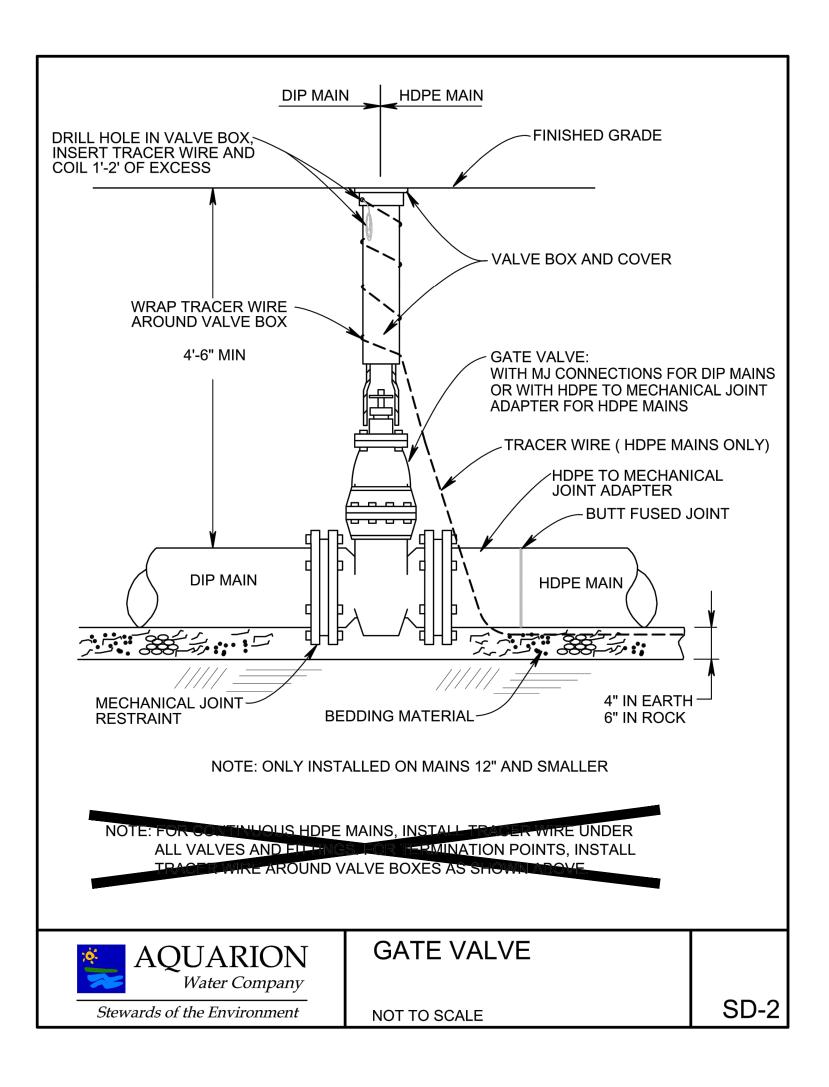
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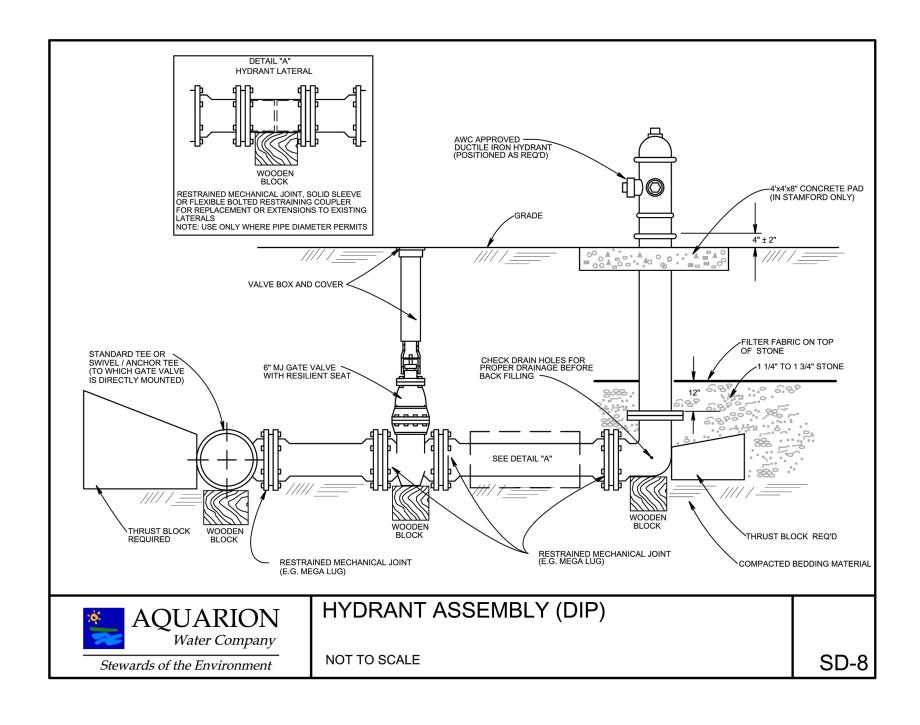
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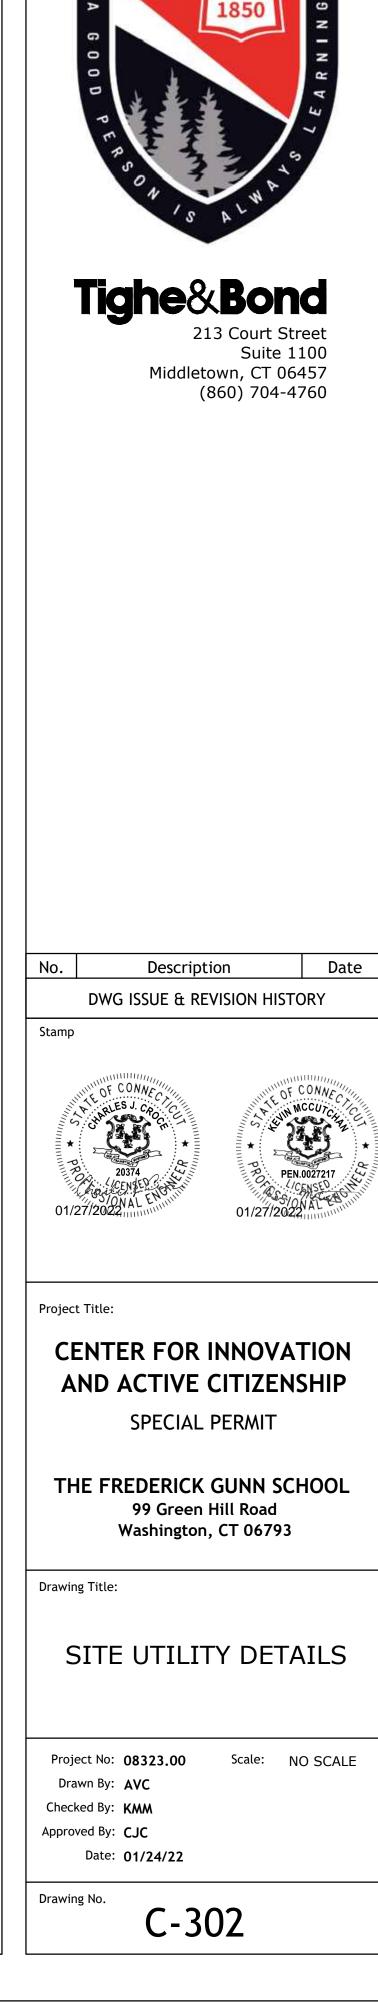
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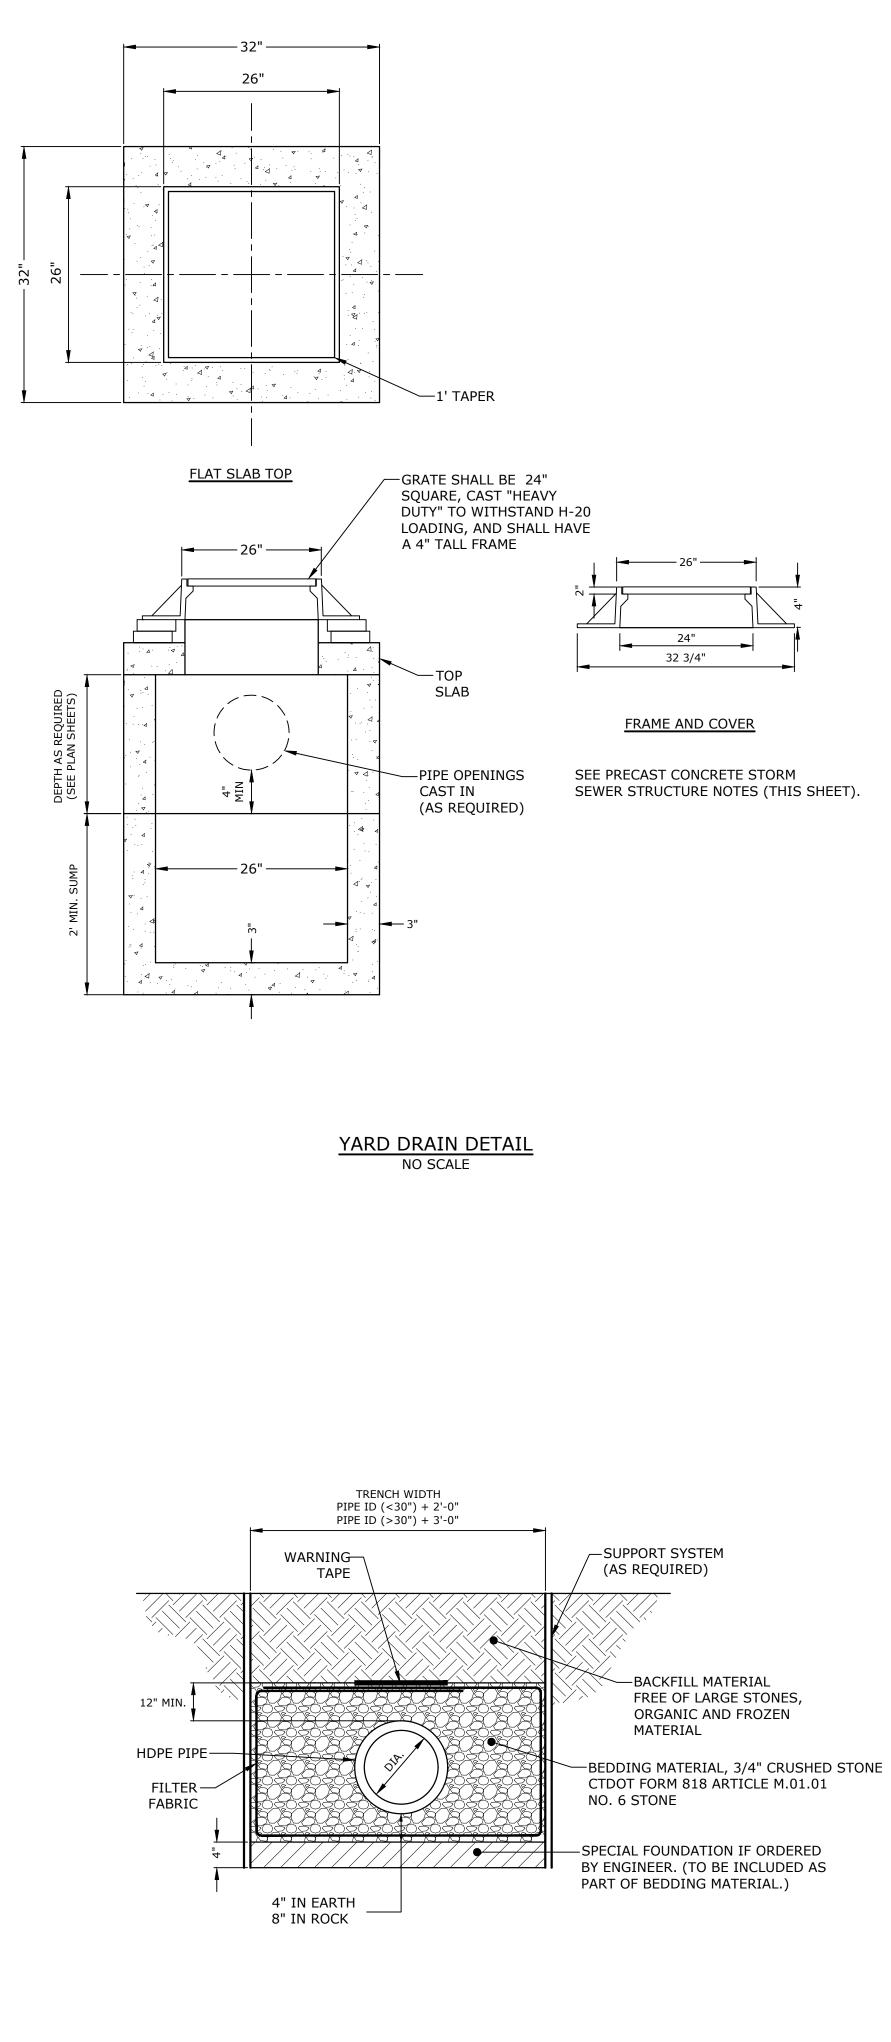
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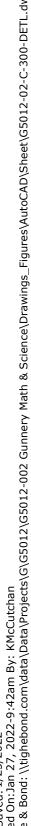




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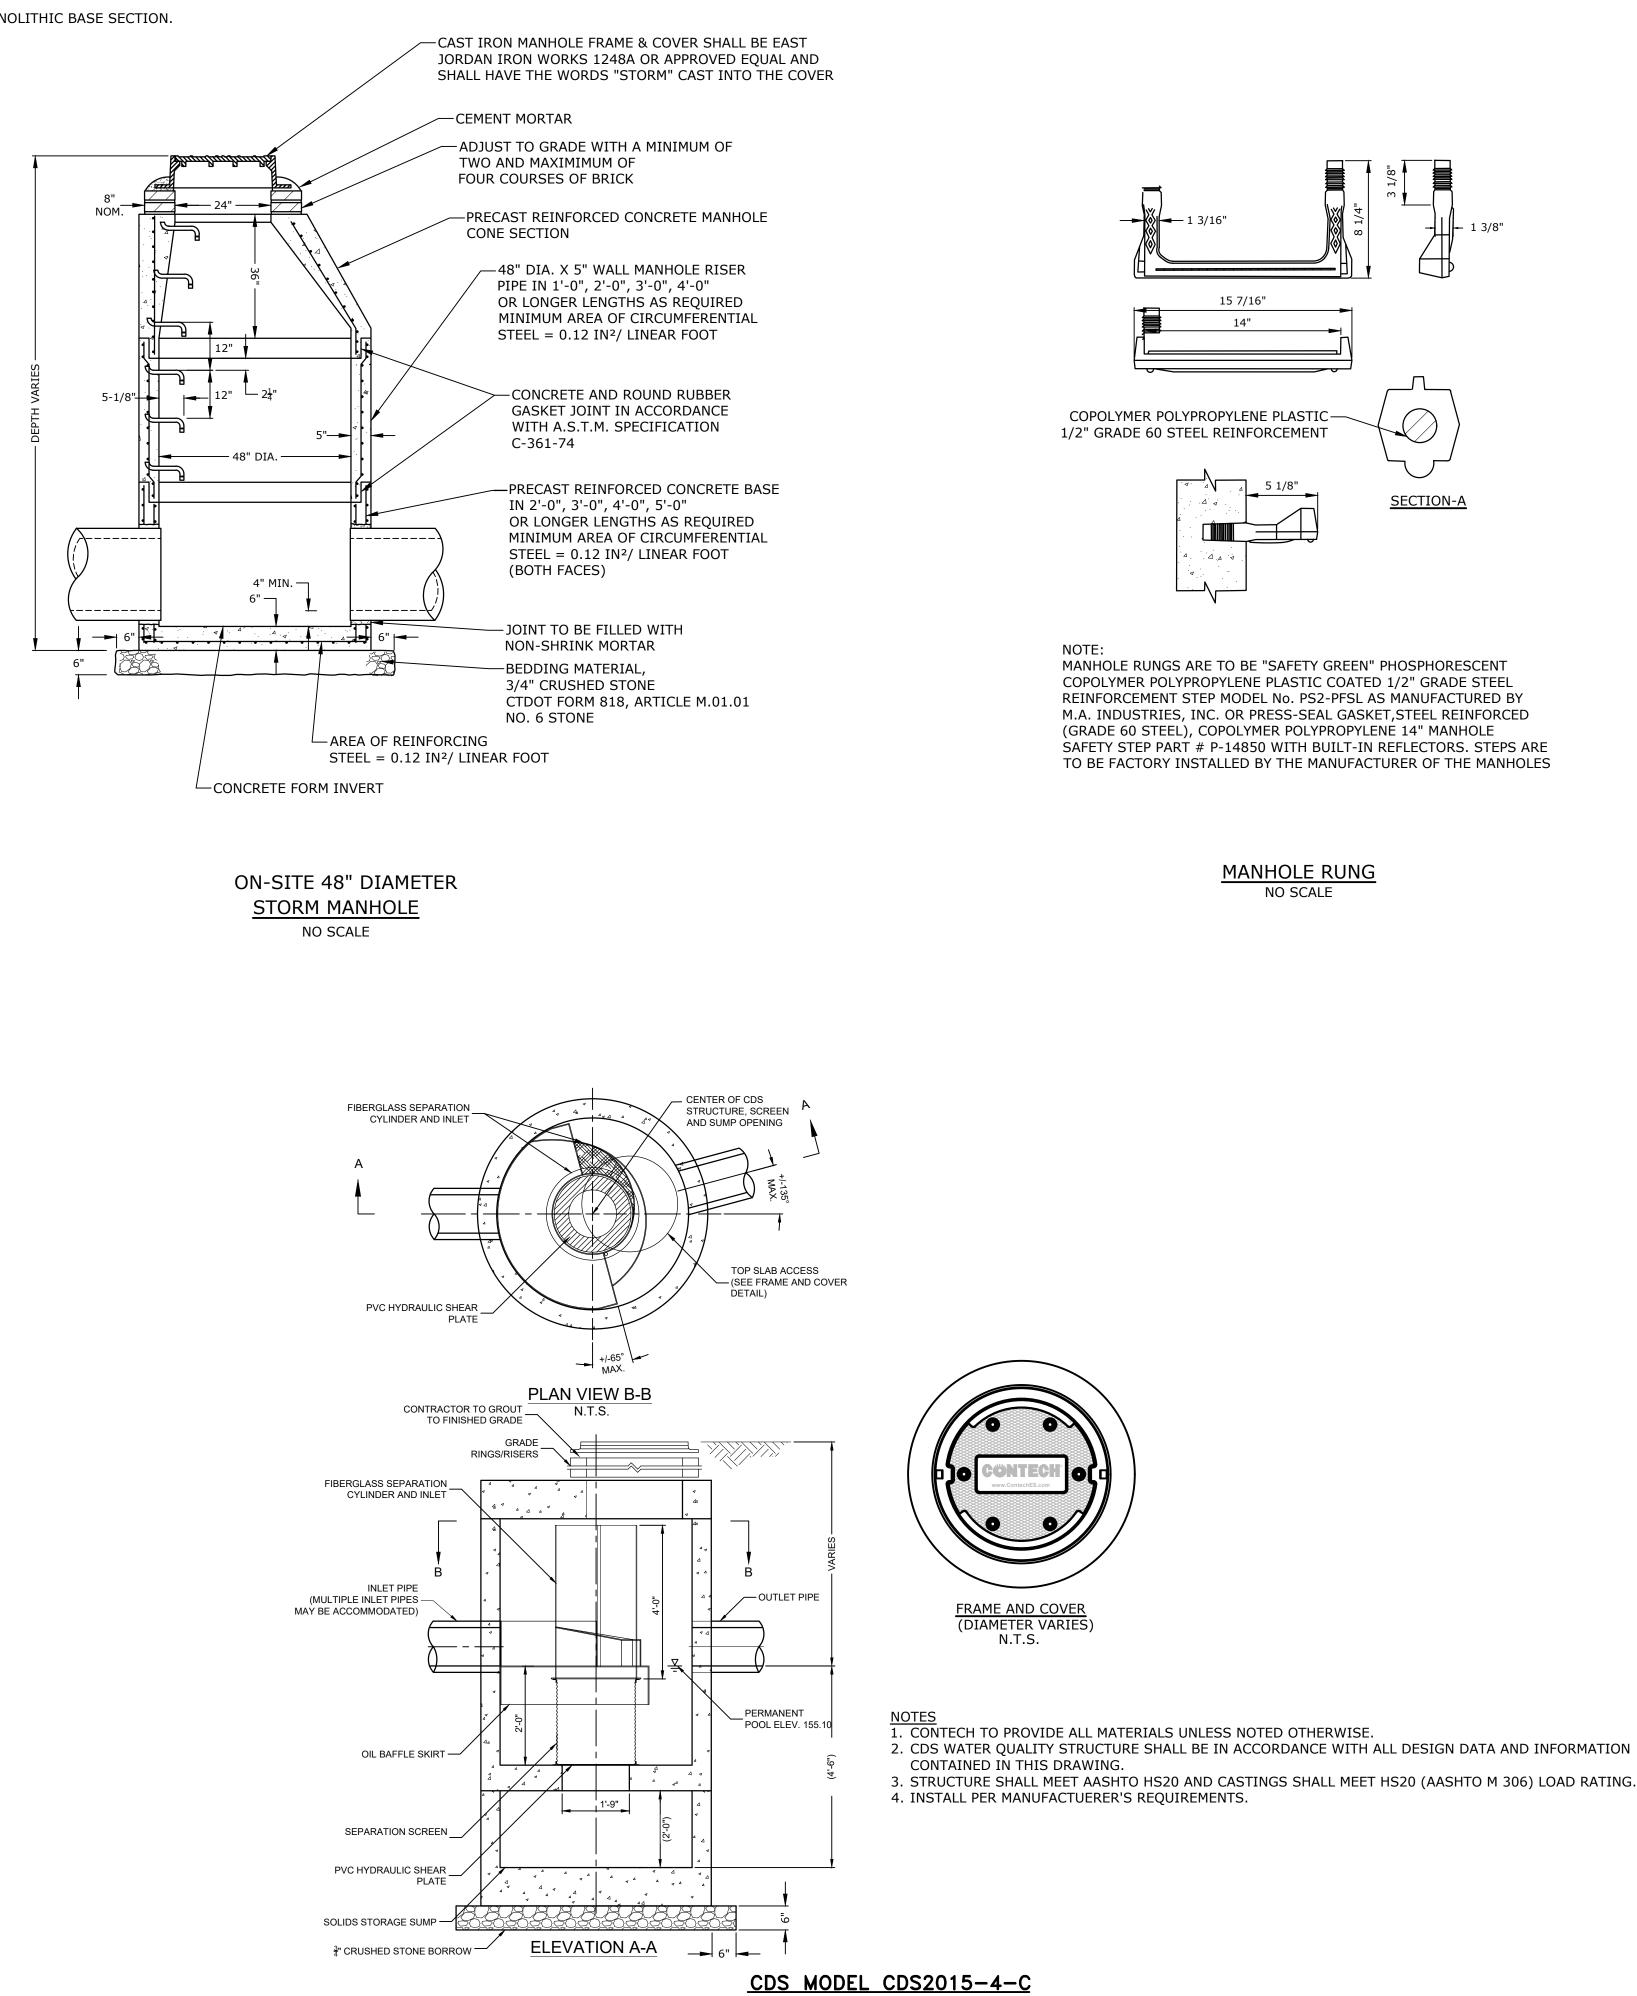




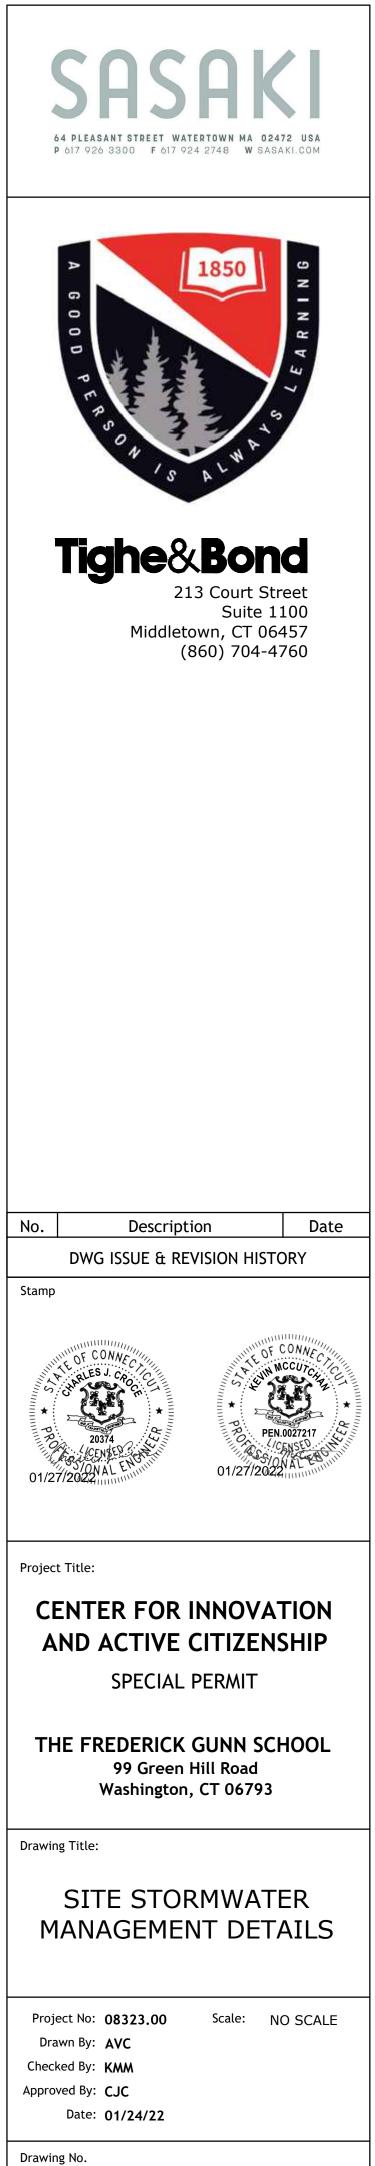
PVC/HDPE TRENCH BEDDING NO SCALE

NOTES: 1. REINFORCING STEEL WELDED WIRE FABRIC SHALL CONFORM TO LATEST ASTM SPECIFICATION A185.

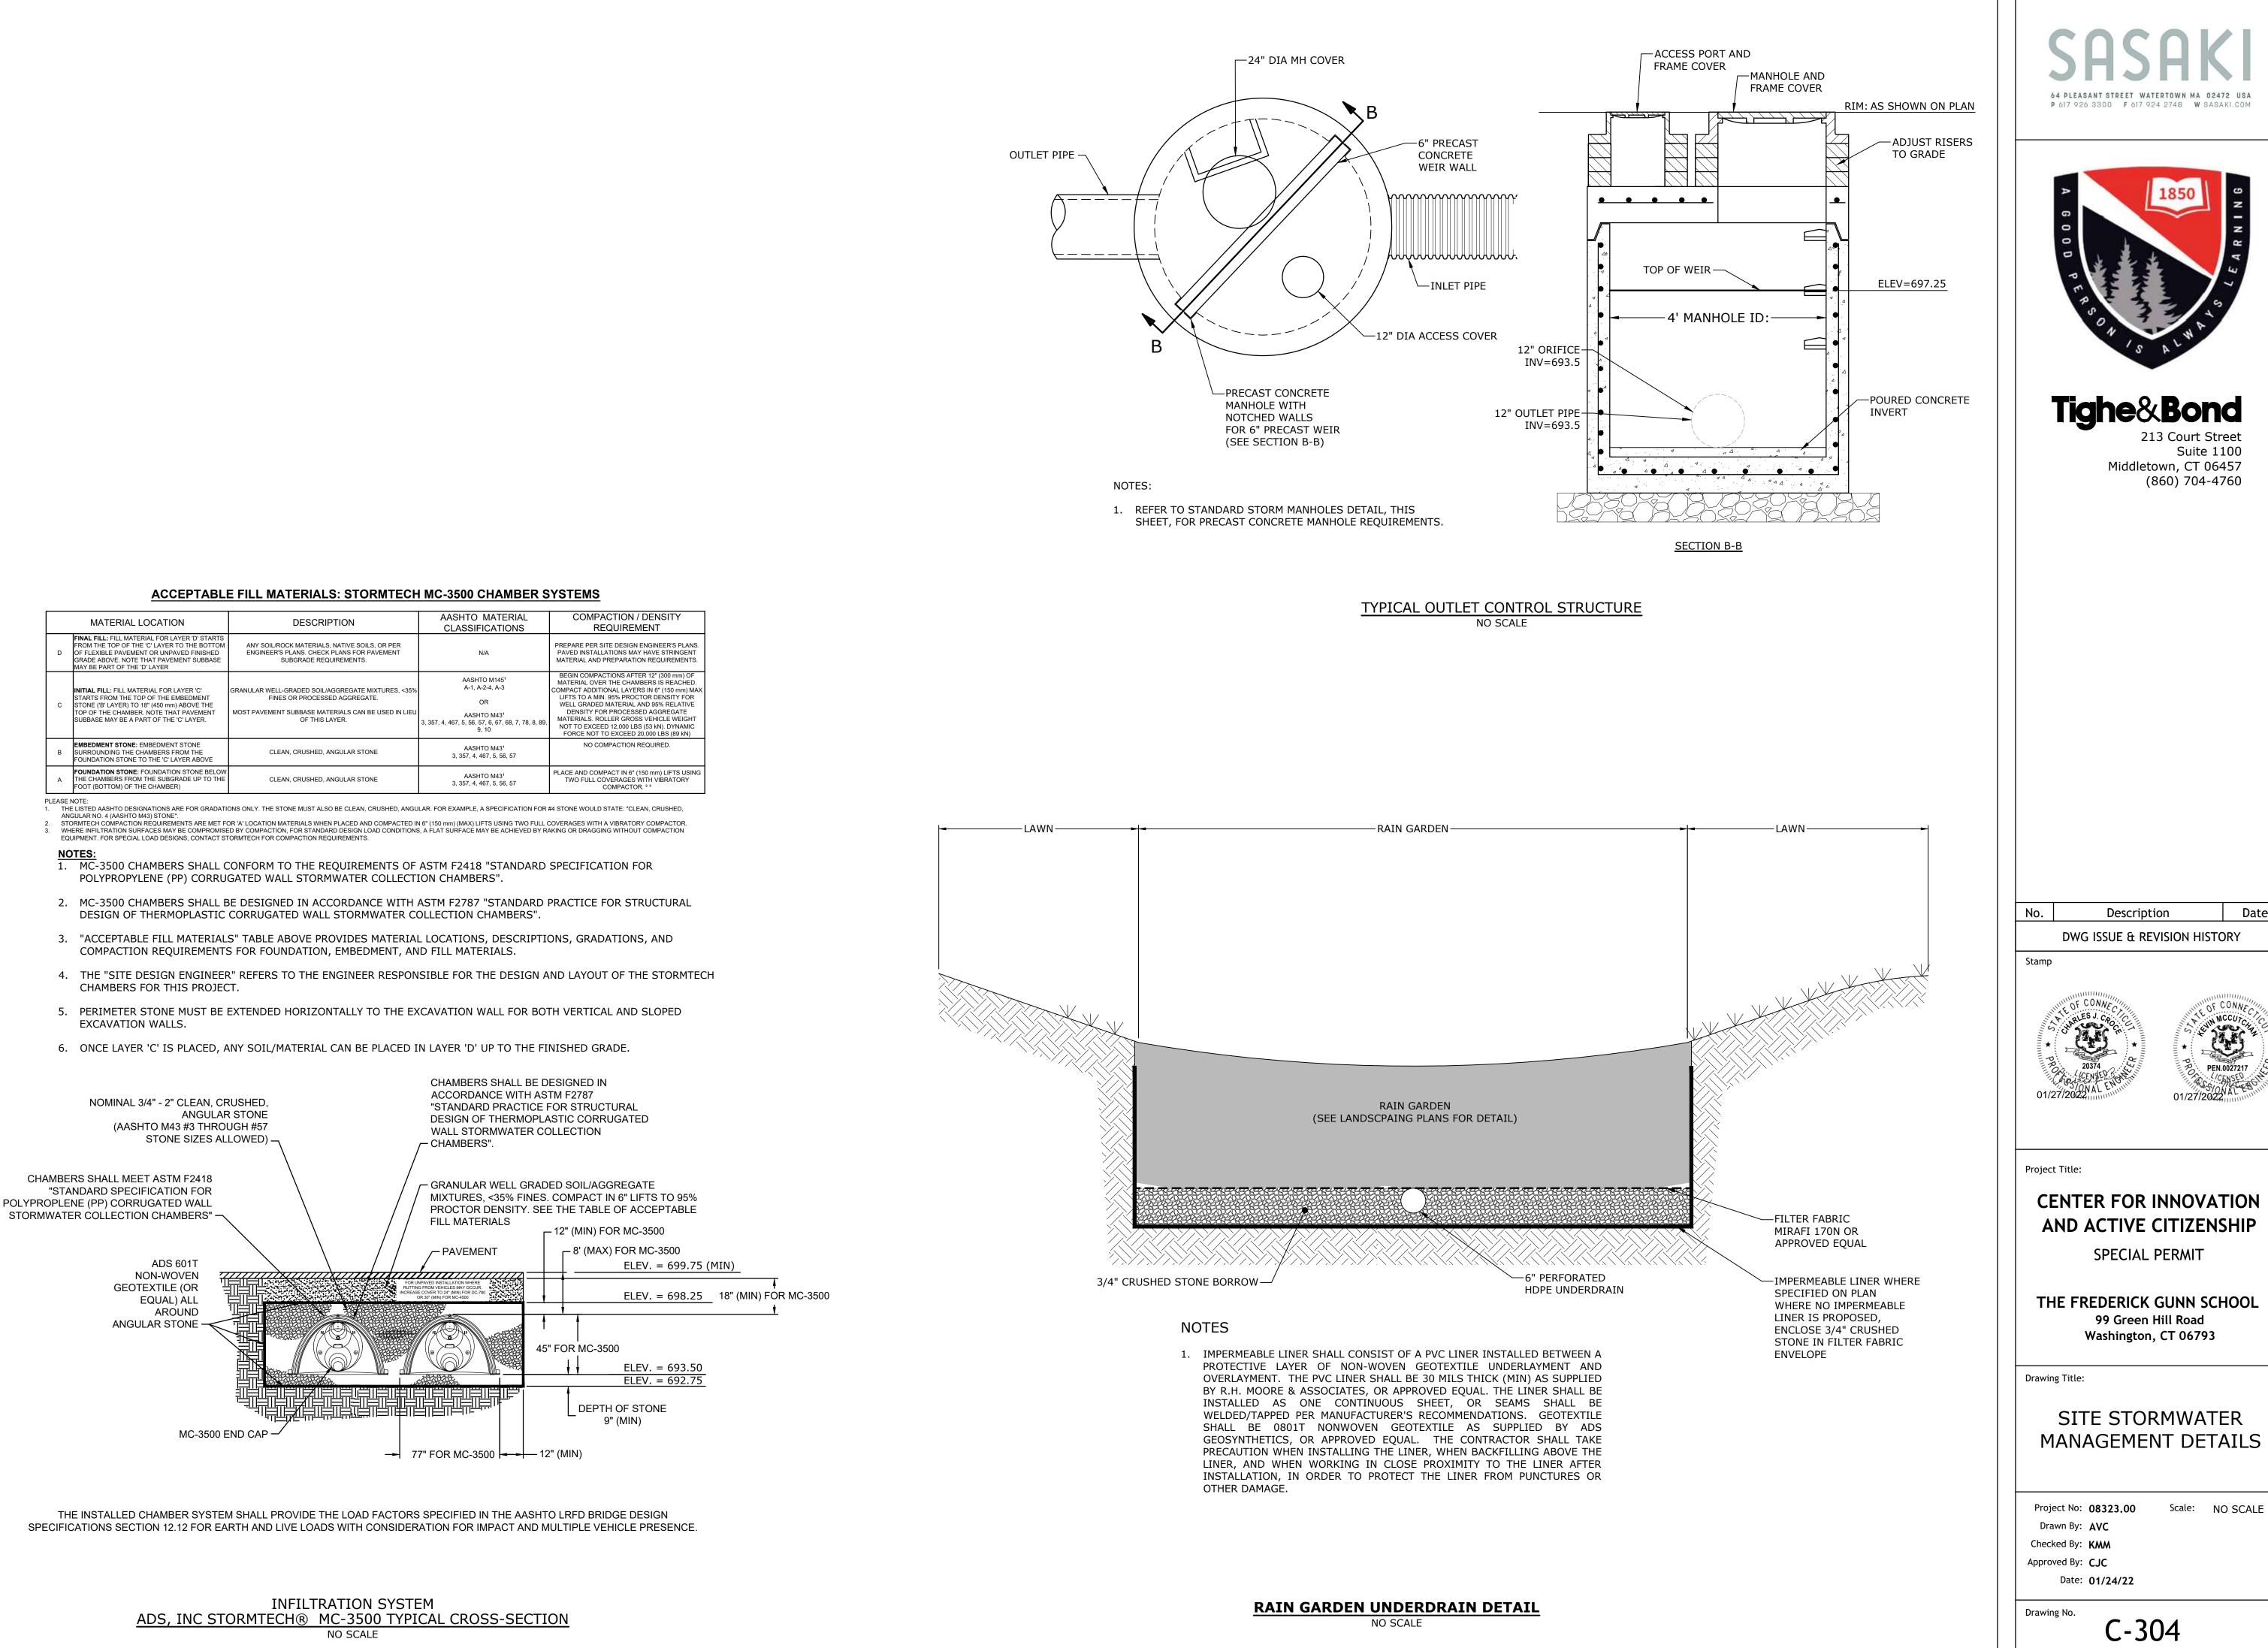
- 2. REINFORCING STEEL DEFORMED BARS SHALL CONFORM TO LATEST ASTM SPECIFICATION A615.
- 3. CONCRETE COMPRESSIVE STRENGTH: 5,000 PSI 28 DAYS.
- 4. MANHOLE STEP TO CONFORM TO OSHA AND ASTM SPECIFICATIONS.
- 5. MONOLITHIC BASE SECTION.

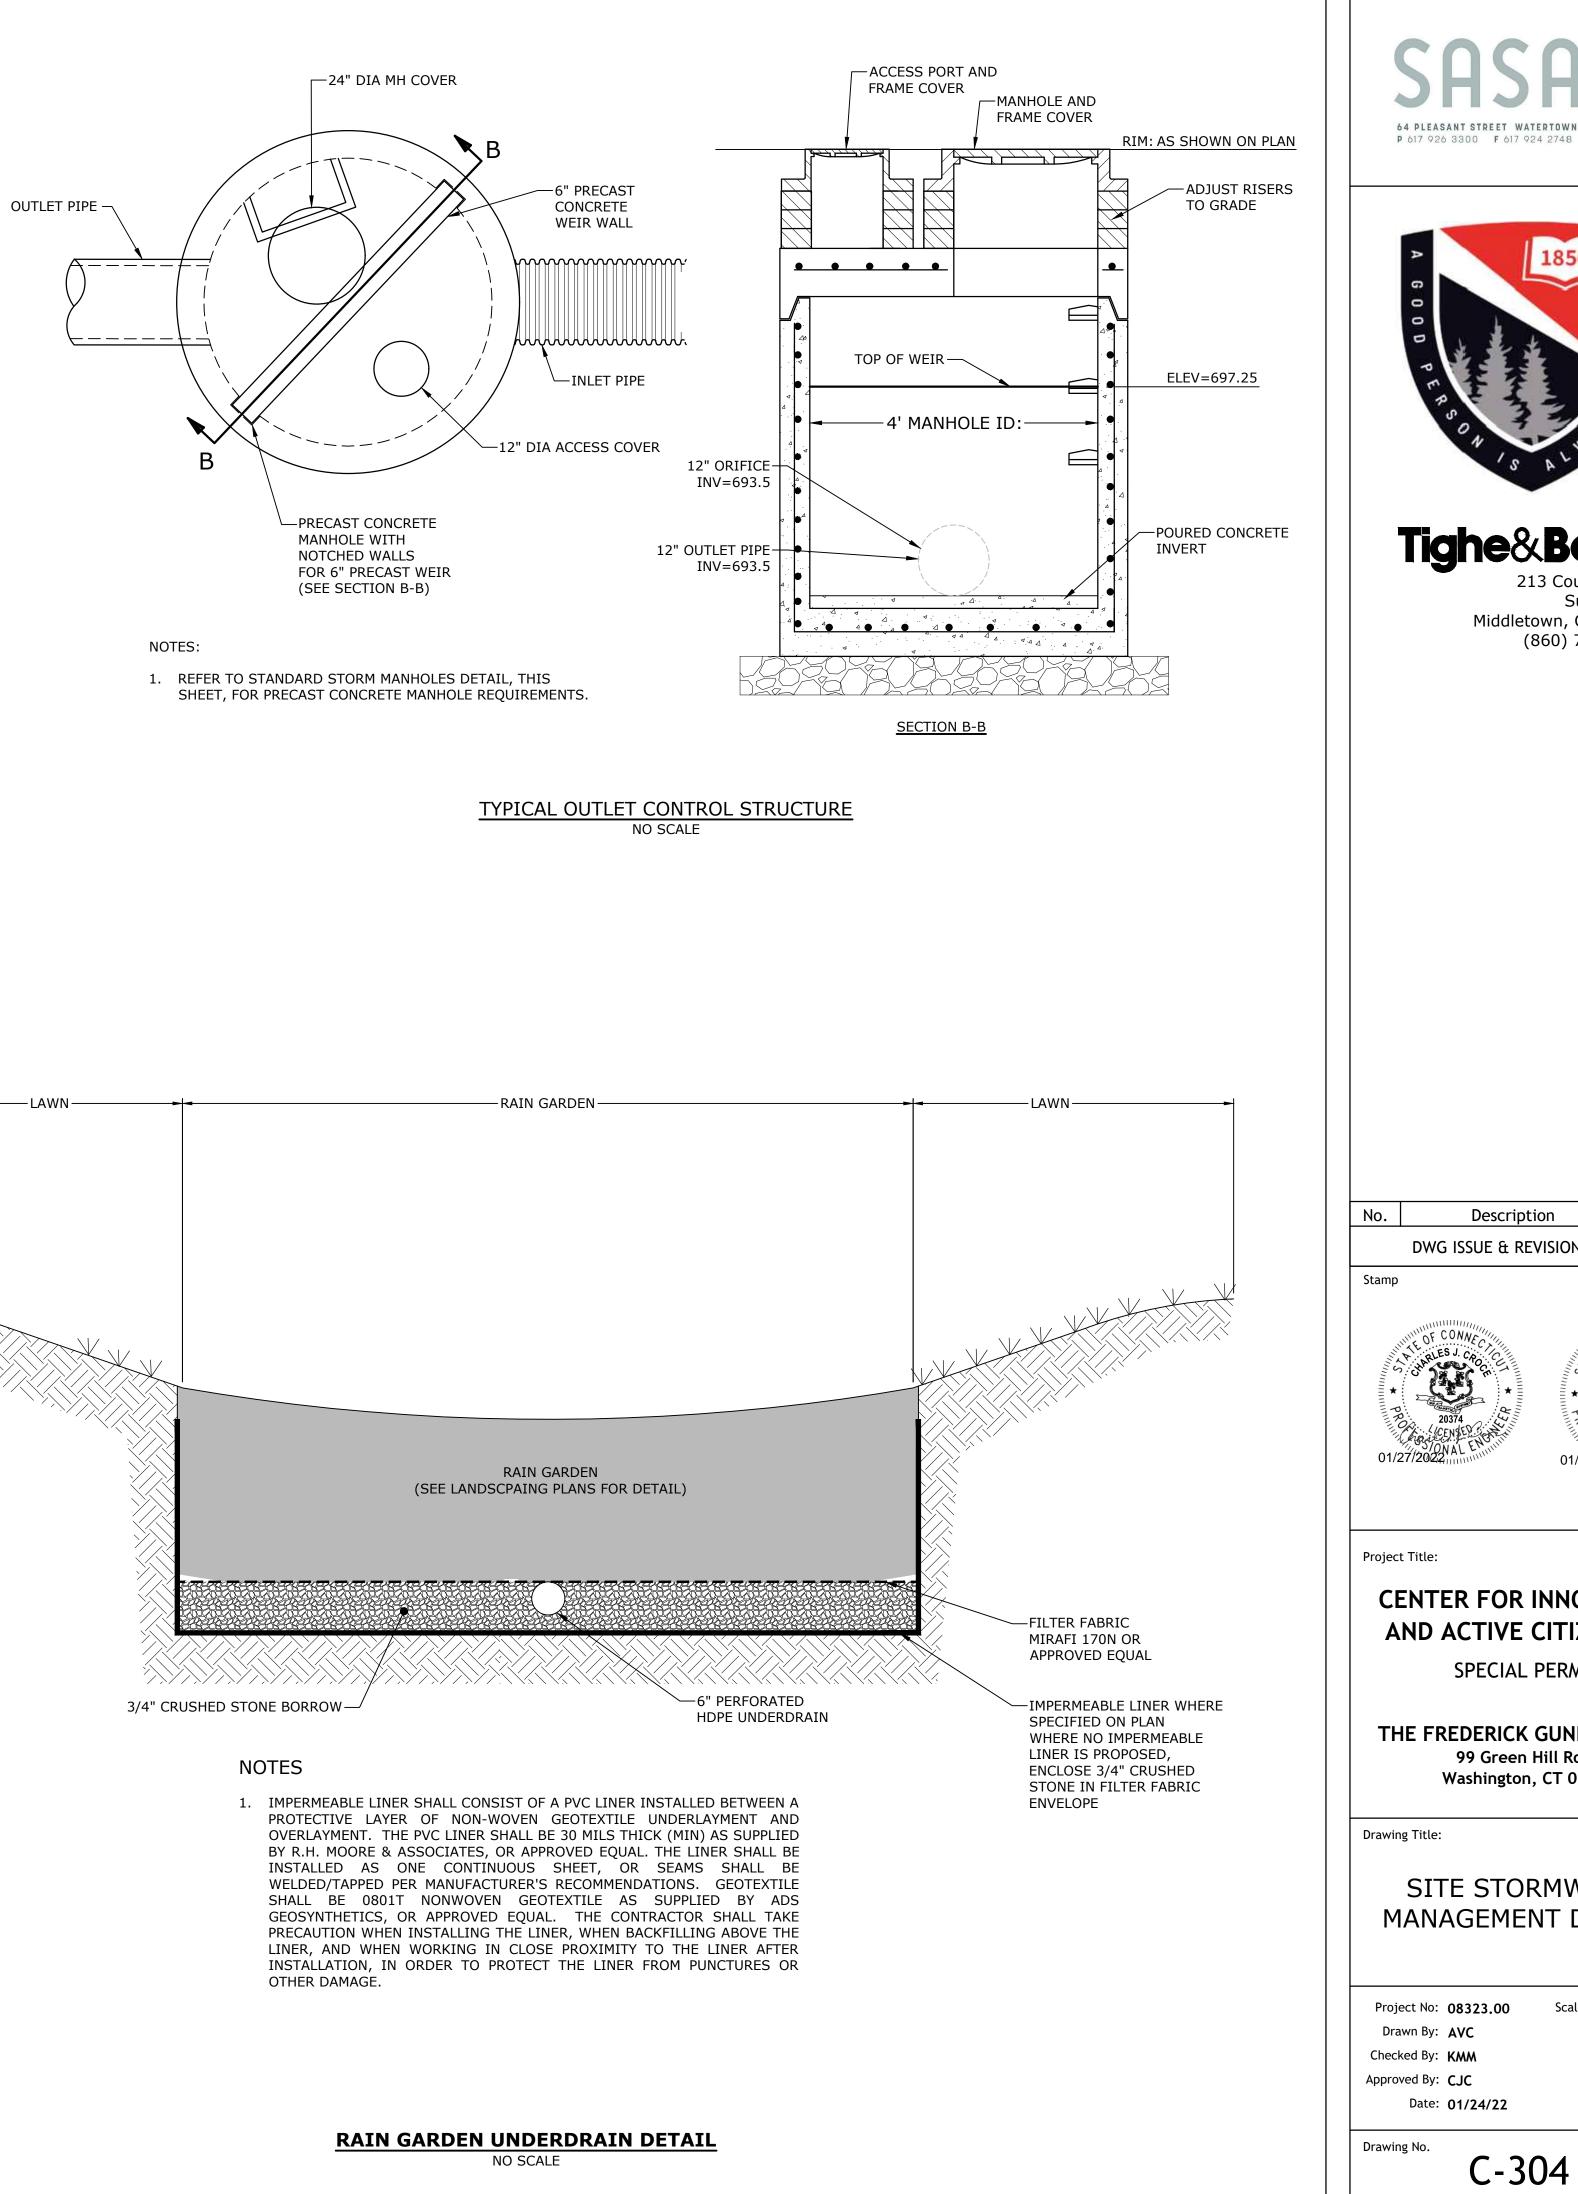


NO SCALE



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Date